

GENERAL NOTES

- Bearings shown hereon are based on the bearings described for Tax Parcel 24-012-023 recorded in Deed Book 2258, page 462, in the Centre County Recorder of Deeds office.
- The underground utilities shown on this survey have been located from field survey information, markings provided by the utility companies and existing drawings obtained from utility companies. The surveyor makes no guarantee that the underground utilities shown comprise all such utilities in the area, either in service or abandoned. The surveyor further does not warrant that the underground utilities shown are in the exact location indicated, although he does certify that they are located as accurately as possible from available information.
- Contour Interval = 1'. Elevations shown hereon are based upon GPS observations on October 20, 2021, and are to the North American Vertical Datum of 1988 (NAVD88)(GEOID12a).
- There was no observed evidence of current earth moving work, building construction or building additions.
- The surveyor knows of no known recent or proposed changes in street right-of-way lines, street or sidewalk construction or repairs.
- There is no observed evidence of this site being used as a solid waste dump, sump, or sanitary landfill.
- Iron pins with cap set are 5/8"Ø rebar, 30" in length with a yellow plastic I.D. cap that bears the inscription "MDM 724-934-2810".
- Basis of Legal Right of Way is PennDOT State Route 3014 Right-of-Way Drawings (MPMS No. 98126), Recorded as H02017-0003
- Contact PennDOT District 2 for Permitting and Right-of-Way information:
 Right-of-Way Centre County
 70 PennDOT Drive 1000 E Bishop St.
 Clearfield, PA 16830 Bellefonte, Pa. 16823
 (814) 765-0467 (814) 355-4731
 Clifton Charles Permits: (814) 765-0512
 ccharles@pa.gov

ZONING INFORMATION

Zoning District - C (General Commercial)
 A car wash is a permitted use within this zoning district.

Minimum Lot Size - 5,000 Sq. Ft.
 Minimum Lot Width - 50 feet
 Minimum Front Yard Setback - 50 feet
 Minimum Side Yard Setback - 15 feet
 Minimum Rear Yard Setback - 20 feet
 Maximum Building Height - 40 feet
 Maximum Lot Coverage - 45%
 Maximum Impervious Coverage - 80%
 Minimum Front Parking Setback - 12 feet
 Side Yard Buffer Setback - 15 feet
 Rear Yard Buffer Setback - 15 feet

Parking Requirements
 Parking Formula - Requires parking study per Planning Commission

Zoning information was obtained from:
 Ferguson Township Planning & Zoning
 3147 Research Drive
 State College, PA 16801
 (814) 238-4651
 Jenna Wargo
 Director Planning & Zoning

Zoning Notes:
 1. There are 11 striped parking spaces, including 1 striped accessible space located on the site. Further investigation may be required to determine compliance to ADA standards and is beyond the scope of this survey.

UTILITY SERVICE INFORMATION

Sanitary Sewer
 Borough of State College
 Sewer Authority
 243 South Allen St.
 State College, PA 16801
 (814) 234-7140
 Amy Kerner
 akerner@statecollegepa.us

Gas Service
 Columbia Gas, PA
 1020 North Hartley St.
 York, PA 17404
 State College, PA 16801
 (717) 849-0160
 Ned Leppo
 nleppo@nisource.com

Water Service
 State College Borough
 Water Authority
 1201 W Branch Rd
 State College, PA 16801
 (814) 238-6766

Electric Service
 West Penn Power Co.
 2800 East College Ave.
 State College, PA 16801
 (814) 231-5355

Cable Service
 Pete Fournier
 Comcast Business Services
 Northeast Division HQ
 676 Island Pond Road,
 Manchester, NH 03109
 mharter@uaja.com
 (603) 541-1099

Telephone Service
 Ferguson Township Public Works
 3147 Research Drive
 State College, PA 16801
 (814) 238-4651
 David Modricker, P.E.

PA ONE-CALL INFORMATION

Serial Number: 20212860672 (Design) 20212860668 (Dig)
 Date of Inquiry: 10/13/2021
 How Contacted: On-line

Company Name	Response			
	All Clear	Has Facilities	Plans	Field Markings
ALL UTILITIES CHECKS	X	X	X	X
COMCAST CABLE	X			
VERIZON TELEPHONE	X			
FERGUSON TWP PUBLIC WORKS	X	X	X	X
WEST PENN POWER	X	X	X	X
PENNSYLVANIA ELECTRIC	X	X	X	X
PENN STATE UNIVERSITY	X			
STATE COLLEGE BOROUGH WATER	X	X	X	X
UNIVERSITY AREA JOINT AUTHORITY	X	X	X	X

SCHEDULE B - SECTION 2 ITEMS

This item will be addressed upon receipt of the current title commitment for the subject premises.

VISIBLE ENCROACHMENTS


There are no noticeable encroachments at the time of the field survey.

FLOOD ZONE NOTE

By graphic plotting only, this site is located in Zone X of the Flood Insurance Rate Map 42027C0617F, Community No. 420270, Panel 0617, Suffix F, bearing an effective date of May 4, 2009 and is not in a special flood hazard area.

LEGAL DESCRIPTION

This item will be addressed upon receipt of the current title commitment for the subject premises.

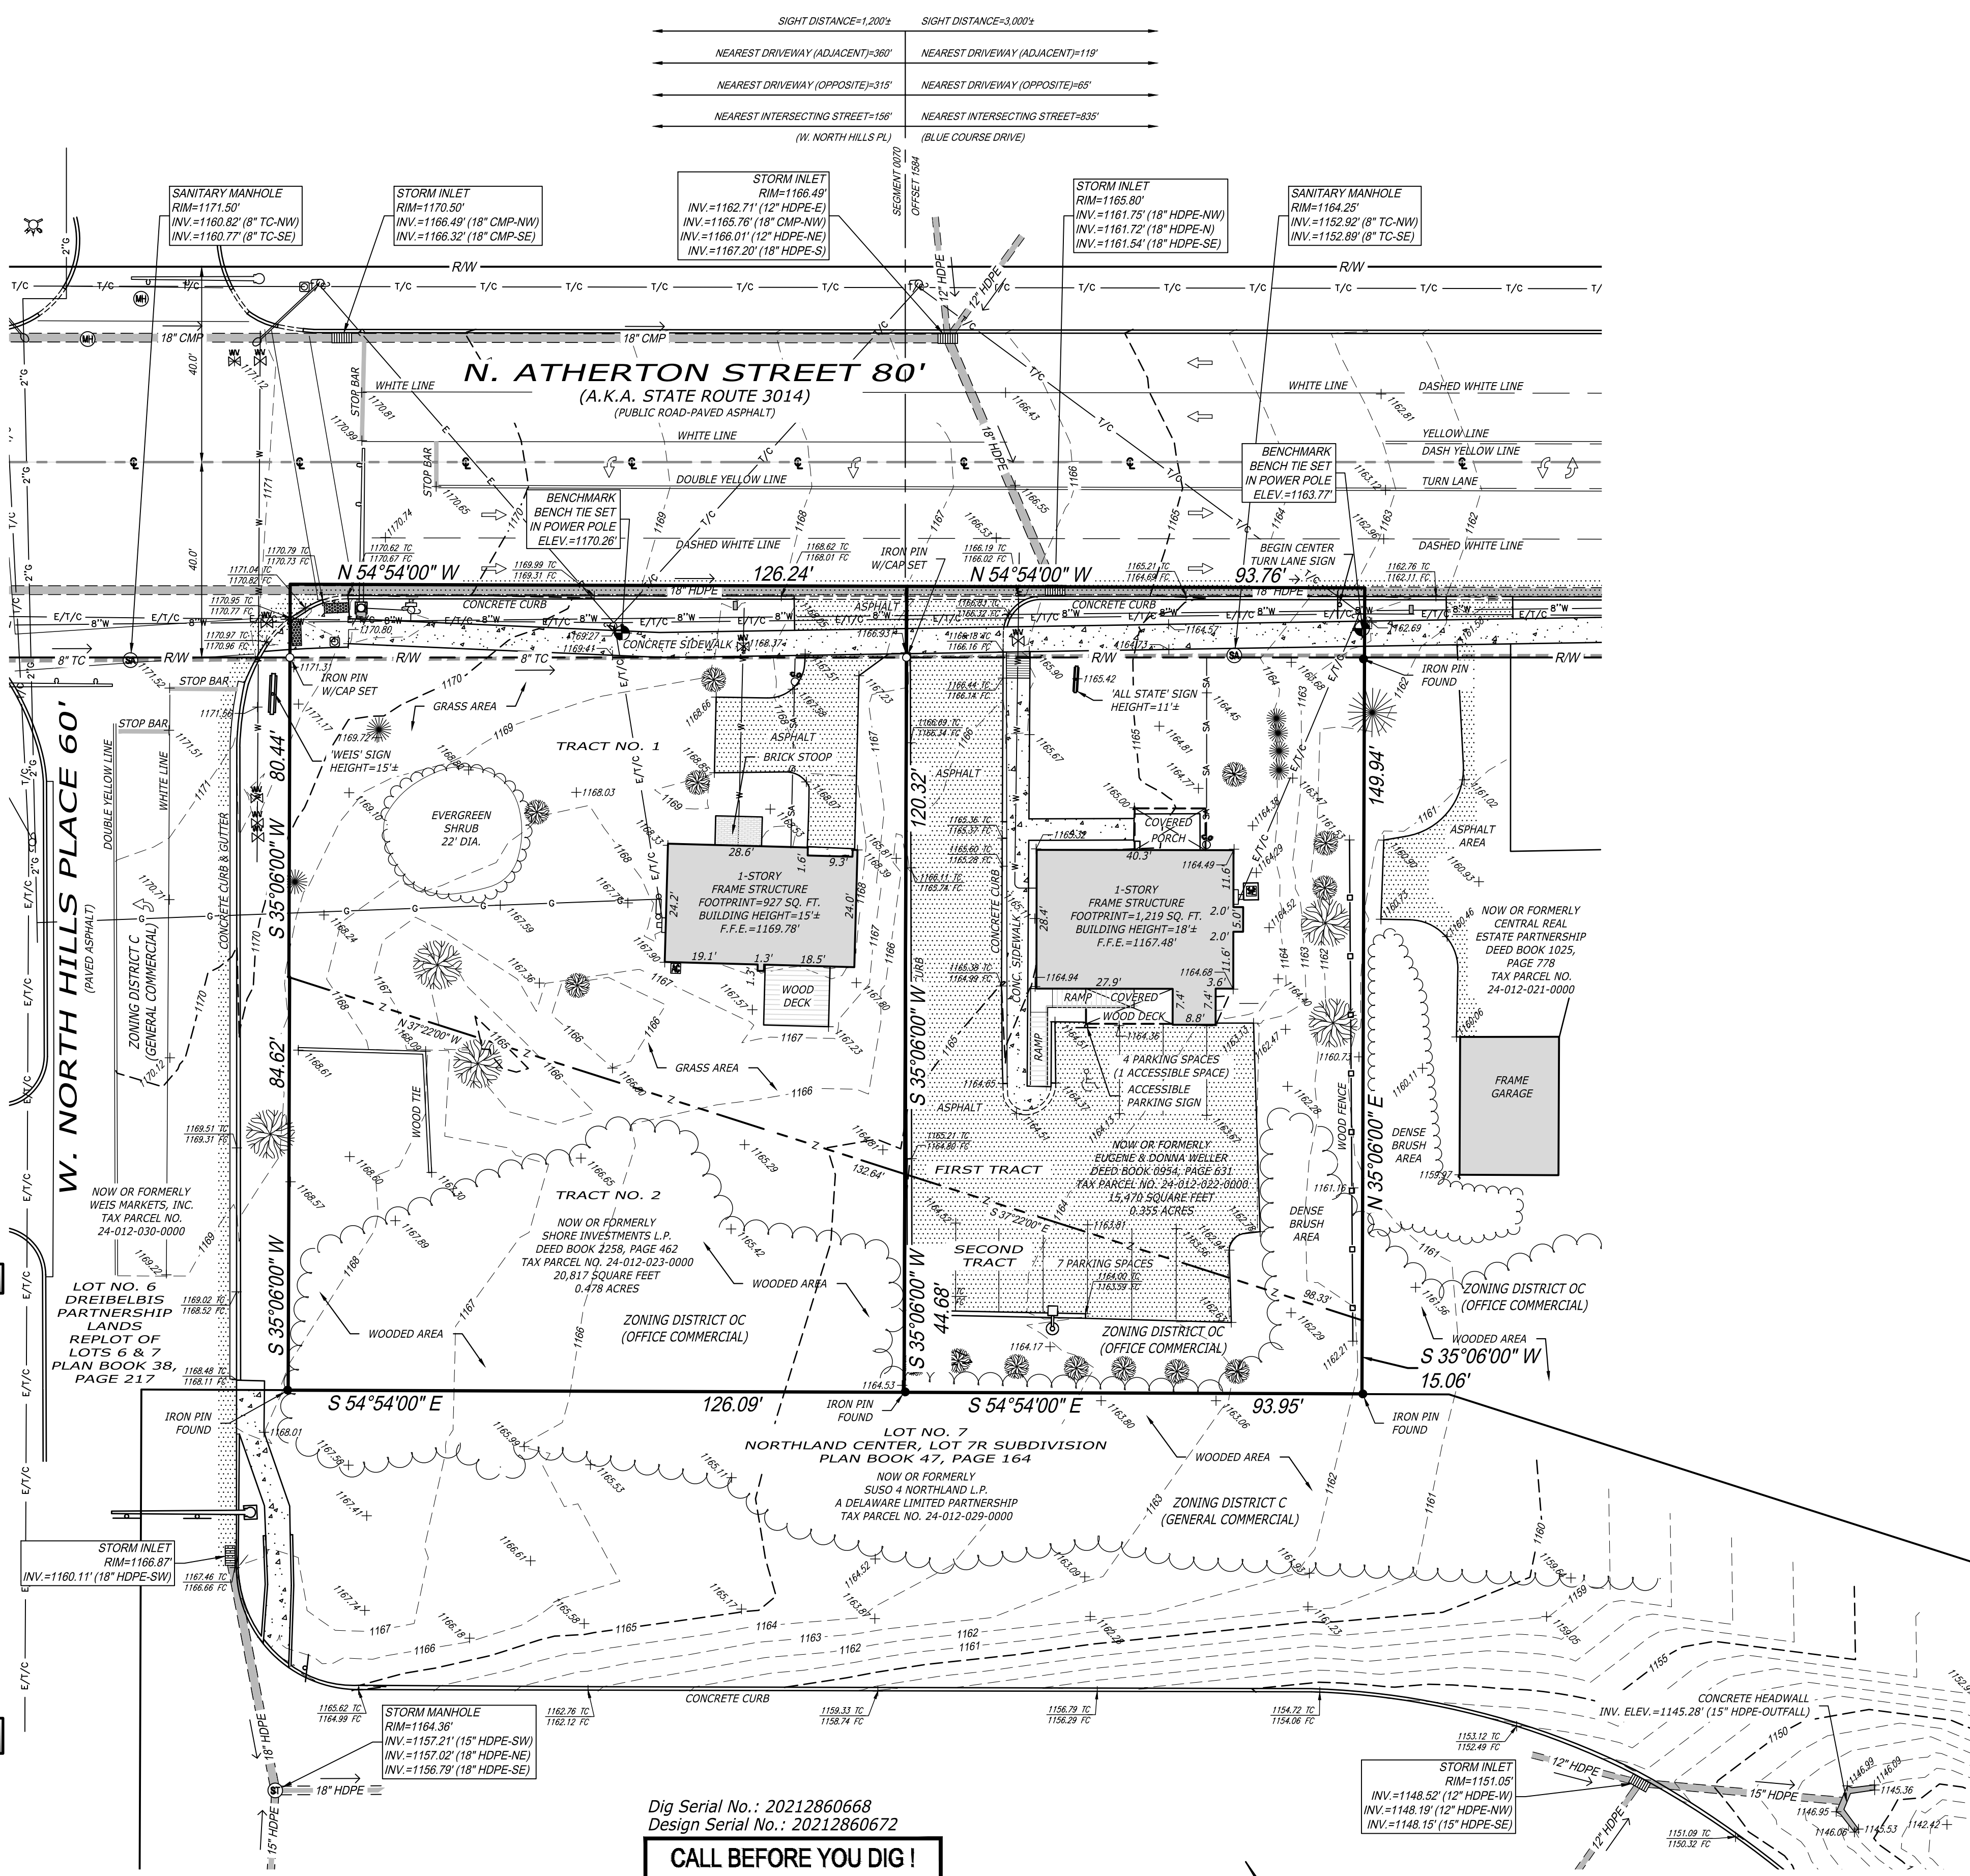

SITE LOCATION MAP
 SCALE: NOT TO SCALE

LEGEND OF SYMBOLS

- Contour Line: --- 1165 ---
- Water Line: --- W ---
- Gas Line: --- G ---
- Overhead Electric, Telephone & Cable Line: --- E/T/C ---
- Overhead Electric Line: --- E ---
- Storm Sewer: --- S ---
- Sanitary Sewer: --- SS ---
- Easements: --- E ---
- Setback Line: --- S ---
- Depressed Curb: --- DC ---
- Wooden/Vinyl Fence: --- WF ---
- Guard Rail: --- GR ---
- Tree Line: --- TL ---
- Signal Poles: --- SP ---
- Sign Poles: --- SPO ---
- Street Light: --- SL ---
- Sanitary Manhole: --- SM ---
- Cleanout: --- CO ---
- Storm Manhole: --- StM ---
- Storm Inlet: --- SI ---
- Manhole: --- MH ---
- Traffic Signal Base: --- TS ---
- Sign: --- S ---
- Illuminated Signs: --- IS ---
- Light Pole: --- LP ---
- Spot Elevation: --- SE ---
- Existing Curb Elevations: --- CE ---
- FC=Top of Curb
- FC=Bottom of Curb
- Benchmark: --- B ---
- Truncated Domes: --- TD ---
- Shrub: --- S ---
- Right-of-Way: --- RW ---
- Terra Cotta: --- TC ---
- Polyvinyl Chloride: --- PVC ---
- High Density Polyethylene: --- HDPE ---
- Finished Floor Elevation: --- F.F.E. ---
- Corrugated Metal Pipe: --- CMP ---
- Reinforced Concrete Pipe: --- RCP ---
- Iron pin w/cap set (Unless otherwise noted)
- Iron Pin Found
- Gas Meter
- Gas Valve
- Water Valve
- Fire Hydrant
- Electric Meter
- Utility Pole
- Guy Wire
- AC Unit
- Traffic Light
- Traffic Flow Arrow
- Turn Arrows
- Handicap Symbol
- Trees
- Asphalt
- Concrete
- Gravel
- Brick

REVISIONS

NO.	DATE	DESCRIPTION
1	11/15/2021	ORIGINAL SUBMITTAL
2	7/27/2022	PER ZONING INFO.

THIS SURVEY WAS PREPARED WITHOUT THE BENEFIT OF A TITLE REPORT, UNLESS SPECIFICALLY NOTED HEREON, AND NO WARRANTY OF ANY KIND IS MADE BY THE SURVEYOR. THE SURVEYOR'S LIABILITY IS LIMITED TO THE PROFESSIONAL SERVICES RENDERED BY THE SURVEYOR. THIS PLAN OR PART OF SURVEY IS ONLY VALID TO THE PARTIES CERTIFIED HEREON. THIS PLAN OR PART OF SURVEY IS ONLY VALID IF ACCOMPANIED BY THE SEAL AND SIGNATURE OF THE LICENSED PROFESSIONAL OF RECORD. ANY REVISIONS TO THIS PLAN OR PART OF SURVEY MUST BE MADE AND SIGNED AND SEALED BY SAID LICENSED PROFESSIONAL. REVISIONS TO THIS PLAN OR PART OF SURVEY MUST BE MADE AND SIGNED AND SEALED BY SAID LICENSED PROFESSIONAL. REVISIONS TO THIS PLAN OR PART OF SURVEY MUST BE MADE AND SIGNED AND SEALED BY SAID LICENSED PROFESSIONAL.

MDM SURVEYORS & ENGINEERS, LLC
 Surveyors • Engineers • Site Planners
 375 Northgate Drive
 State College, PA 16801
 Ph: (724) 934-2810 Fax: (724) 934-2811
 mdsurvey@mdmic.com
 www.mdmic.com

All Washed Up Auto Spa
 1380 & 1386 N. Atherton Street
 Township of Ferguson, County of Centre
 Commonwealth of Pennsylvania

EXISTING CONDITIONS SURVEY

SURVEYOR'S CERTIFICATION


All Washed Up Auto Spa
 1380 & 1386 N. Atherton Street
 Township of Ferguson, County of Centre
 Commonwealth of Pennsylvania

Certified To: All Washed Up Auto Spa



This is to certify that this map or plat and the survey on which it is based were made in accordance with the 2021 Minimum Standard Detail Requirements for ALTA/NSPS Land Title Surveys, jointly established and adopted by ALTA and NSPS, and includes Items 1, 2, 3, 4, 5, 6(a), 6(b), 7(a), 8, 9, 10, 11(a), 13 and 16-19 of Table A thereof. The fieldwork was completed on October 20, 2021.

Date of Plat or Map: July 27, 2022
 Christopher R. Jackson
 Christopher R. Jackson, PLS
 Professional Land Surveyor No. SU075499
 In The Commonwealth of Pennsylvania

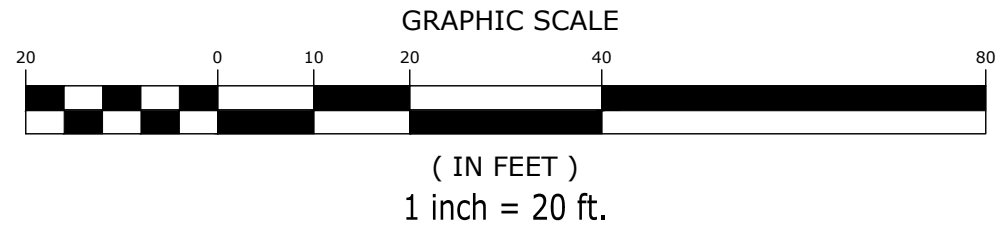

Dig Serial No.: 20212860668
 Design Serial No.: 20212860672


CALL BEFORE YOU DIG!
 PENNSYLVANIA LAW REQUIRES
 3 WORKING DAYS NOTICE FOR
 CONSTRUCTION PHASE AND 10 WORKING
 DAYS IN DESIGN STAGE - STOP CALL
 PENNSYLVANIA ONE CALL SYSTEM, INC.
 1-800-242-1776



SITE LOCATION MAP
SCALE: NOT TO SCALE

Dig Serial No.: 2021286068
Design Serial No.: 2021286072

CALL BEFORE YOU DIG!
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3 WORKING DAYS NOTICE FOR
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DAYS IN DESIGN STAGE - STOP CALL
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1-800-242-1776

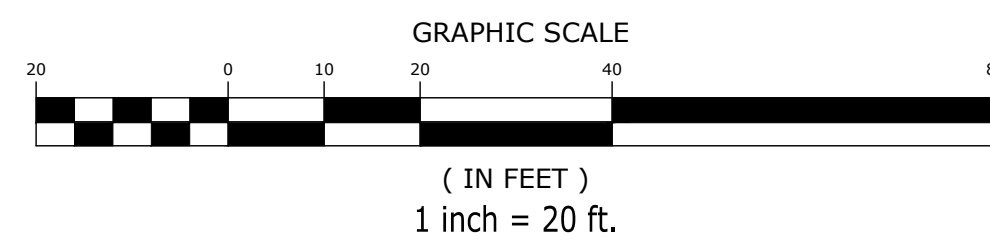

DEMOLITION NOTES


- CONTRACTOR TO REVIEW PHASE II REPORT FOR SITE AND TO BE FAMILIAR WITH ANY AND ALL MATERIALS THAT MAY BE ENCOUNTERED OR OUTLINED IN PHASE II REPORT.
- ALL WORK TO BE ACCOMPLISHED IN STRICT ACCORDANCE WITH ALL LOCAL ORDINANCES, CITY OR STATE.
- WITHIN THE SUBJECT PROPERTY, THE INTENT IS TO HAVE A CLEAN, CLEAR SITE, FREE OF ALL EXISTING ITEMS NOTED TO BE REMOVED IN ORDER TO PERMIT THE CONSTRUCTION OF THE NEW PROJECT.
- ALL ITEMS NOTED TO BE REMOVED BY THE SELLER SHALL BE ACCOMPLISHED PRIOR TO THE CLOSING OF THE REAL ESTATE TRANSACTION. ALL OTHER ITEMS NOTED TO BE REMOVED SHALL BE DONE SO AS PART OF THE CONTRACT FOR GENERAL CONSTRUCTION.
- REMOVE ALL UTILITIES TO EXISTING STRUCTURES WHETHER SHOWN OR NOT. CUT AND CAP ALL UNDERGROUND LINES AT THE PROPERTY LINE UNLESS OTHERWISE NOTED.
- FOR ALL ITEMS NOTED TO BE REMOVED - REMOVE NOT ONLY THE ABOVE GROUND ELEMENTS, BUT ALL UNDERGROUND ELEMENTS AS WELL, INCLUDING BUT NOT NECESSARILY LIMITED TO: FOUNDATIONS, GRAVEL FILLS, TREE ROOTS, OLD PIPE, ETC.
- BACKFILL ALL EXCAVATIONS RESULTING FROM THE DEMOLITION WORK TO MEET THE REQUIREMENTS FOR FILL OUTLINED IN THE SOILS REPORT.
- GENERAL CONTRACTOR IS RESPONSIBLE TO VERIFY, PRIOR TO THE FINAL CONTRACT EXECUTION, IF ANY BUILDING STRUCTURE THAT IS NOTED TO BE REMOVED HAS A BASEMENT. IF SO THE BUILDING STRUCTURE, BOTH FLOOR STRUCTURES, BASEMENT, FOUNDATION, ETC. ARE TO BE REMOVED AND BACKFILLED TO EXISTING GRADE ELEVATIONS SURROUNDING THE EXISTING STRUCTURE.
- DEMOLITION SHOULD NOT BEGIN UNTIL E&S CONTROLS HAVE BEEN COMPLETED.
- CONTRACTOR SHALL INSTALL 6' HIGH TEMPORARY CHAIN LINK FENCE AROUND PROPOSED WORK AREA, COMPLETE WITH VEHICLE GATE, MAN GATE, AND APPROPRIATE SIGNAGE AS REQUIRED BY LOCAL MUNICIPALITY. THE CONTRACTOR SHALL COORDINATE THE EXACT LOCATION OF THE TEMPORARY CONSTRUCTION FENCE IN THE FIELD WITH THE OWNER, THE LOCAL MUNICIPALITY AND COUNTY, AND CONSTRUCTION MANAGER.
- THE CONTRACTOR SHALL BE RESPONSIBLE FOR THE MAINTENANCE AND PROTECTION OF TRAFFIC THROUGHOUT CONSTRUCTION AND SHALL INSTALL TRAFFIC CONTROL DEVICES, SIGNAGE, AND UTILIZE FLAGMEN AS NECESSARY. TRAFFIC CONTROL DEVICES SHALL BE IN ACCORDANCE WITH STATE AND LOCAL REQUIREMENTS.

UTILITY CONTACTS

SANITARY SEWER BOROUGH OF STATE COLLEGE SEWER AUTHORITY 243 SOUTH ALLEN ST. STATE COLLEGE, PA 16801 (814) 234-7140 AMY KERNER akerner@statecollegepa.us	GAS SERVICE COLUMBIA GAS, PA 1020 NORTH HARTLEY ST. YORK, PA 17404 (717) 849-0160 NED LEPPA nleppo@ninsource.com	WATER SERVICE STATE COLLEGE BOROUGH WATER AUTHORITY 1201 W BRANCH RD STATE COLLEGE, PA 16801 (814) 238-6766
STORM SEWER UNIVERSITY AREA JOINT AUTHORITY 1576 SPRING VALLEY RD STATE COLLEGE, PA 16801 (814) 238-5361 EXT. 7715 MARK HARTER mharter@uaja.com	CABLE SERVICE COMCAST BUSINESS SERVICES NORTHEAST DIVISION HQ 676 ISLAND POND ROAD, MANCHESTER, NH 03109 PETE FOURNIER (603) 541-1099	ELECTRIC SERVICE WEST PENN POWER CO. 2800 EAST COLLEGE AVE. STATE COLLEGE, PA 16801 (814) 231-5355
STORM SEWER FERGUSON TOWNSHIP PUBLIC WORKS 3147 RESEARCH DRIVE STATE COLLEGE, PA 16801 (814) 238-4651 DAVID MODRICKER, P.E.	TELEPHONE SERVICE VERIZON, PA 250 SOUTH ALLEN ST. (814) 231-6565 (877) 596-7577	


KEYNOTES

- CLEAR AND GRUB SITE, AS REQUIRED, FOR NEW SITE IMPROVEMENTS. SEE E&S PLAN FOR LIMITS OF DISTURBANCE.
- REMOVE EXISTING BUILDING, INCLUDING BASE, FOUNDATION, PORCHES, DECKS, ETC., AND PREP FOR NEW BUILDING/GRADING.
- SAWCUT AND REMOVE EXISTING ASPHALT PAVEMENT, AND PREP FOR NEW PAVEMENT OR GRADING.
- SAWCUT AND REMOVE EXISTING CONCRETE CURB.
- SAWCUT AND REMOVE EXISTING CONCRETE SIDEWALK, RAMP AND CURB. PROTECT REMAINING EDGE DURING CONSTRUCTION.
- REMOVE EXISTING RAILING.
- REMOVE EXISTING LOT LIGHT, INCLUDING CONCRETE BASE, CONDUITS, WIRING, ETC.
- REMOVE EXISTING ROAD IDENTIFICATION SIGN, INCLUDING BASE, CONDUITS, WIRING, ETC.
- REMOVE EXISTING SIGN AND BASE.
- REMOVE EXISTING SANITARY CLEANOUT AND PIPING, AND PREP FOR NEW SANITARY CONNECTION, AS REQUIRED. SEE SITE UTILITY PLAN. PLUG AND CAP SANITARY TAP AT MAIN NOT SCHEDULED FOR RE-USE, PER SANITARY AUTHORITY REQUIREMENTS.
- REMOVE EXISTING GAS METER AND PORTION OF GAS LATERAL, AND PREP FOR NEW GAS METER CONNECTION TO EXISTING LATERAL. COORDINATE WITH GAS COMPANY. SEE SITE UTILITY PLAN.
- REMOVE EXISTING ELECTRIC METER AND OVERHEAD UTILITY LINES. COORDINATE WITH UTILITY COMPANIES.
- REMOVE EXISTING WATER LINE. CAP AND PLUG LINE AT WATER MAIN, PER WATER AUTHORITY REQUIREMENTS.
- REMOVE EXISTING TREE, INCLUDING ROOT SYSTEM.
- REMOVE EXISTING AC UNITS AND WIRING TO BUILDING.
- REMOVE EXISTING WOOD TIES.
- EXISTING CONCRETE SIDEWALK TO REMAIN. PROTECT DURING CONSTRUCTION. REPAIR/REPLACE ANY SECTIONS NOT IN GOOD CONDITION OR BETTER.
- EXISTING CONCRETE CURB TO REMAIN. PROTECT DURING CONSTRUCTION.
- REMOVE EXISTING WOOD FENCE, INCLUDING POSTS AND FOUNDATIONS.
- EXISTING SANITARY MANHOLE AND 8" O.T.C. PIPE TO REMAIN. PROTECT DURING CONSTRUCTION. CONFIRM LOCATION, DEPTH, SIZE, ETC., PRIOR TO ANY CONSTRUCTION ACTIVITIES, AND PREP FOR NEW SANITARY LATERAL CONNECTION. SEE SITE UTILITY PLAN.
- EXISTING TREES TO REMAIN. PROTECT DURING CONSTRUCTION.
- EXISTING UTILITY POLE AND OVERHEAD ELECTRIC/TELEPHONE/CABLE LINE TO REMAIN. PROTECT DURING CONSTRUCTION.
- EXISTING ROAD IDENTIFICATION SIGN TO REMAIN. PROTECT DURING CONSTRUCTION.
- EXISTING TREES TO BE REMOVED AND TEMPORARILY SEATED FOR FUTURE RELOCATION (TYP. FOR 2). SEE LANDSCAPE PLAN.
- REMOVE EXISTING DEPRESSED CURB AND PREP FOR NEW FULL-DEPTH CONCRETE CURB. SEE SITE PLAN. PROTECT REMAINING EDGE OF ROADBED.
- REMOVE EXISTING CURB AND PREP FOR NEW DEPRESSED CURB AT NEW DRIVEWAY. SEE SITE PLAN. PROTECT REMAINING EDGE OF ROADBED.
- EXISTING DEPRESSED CURB TO REMAIN. PROTECT DURING CONSTRUCTION. REPAIR/REPLACE ANY FULL SECTIONS NOT IN GOOD CONDITION OR BETTER.
- REMOVE EXISTING TREE, INCLUDING ROOT SYSTEM.

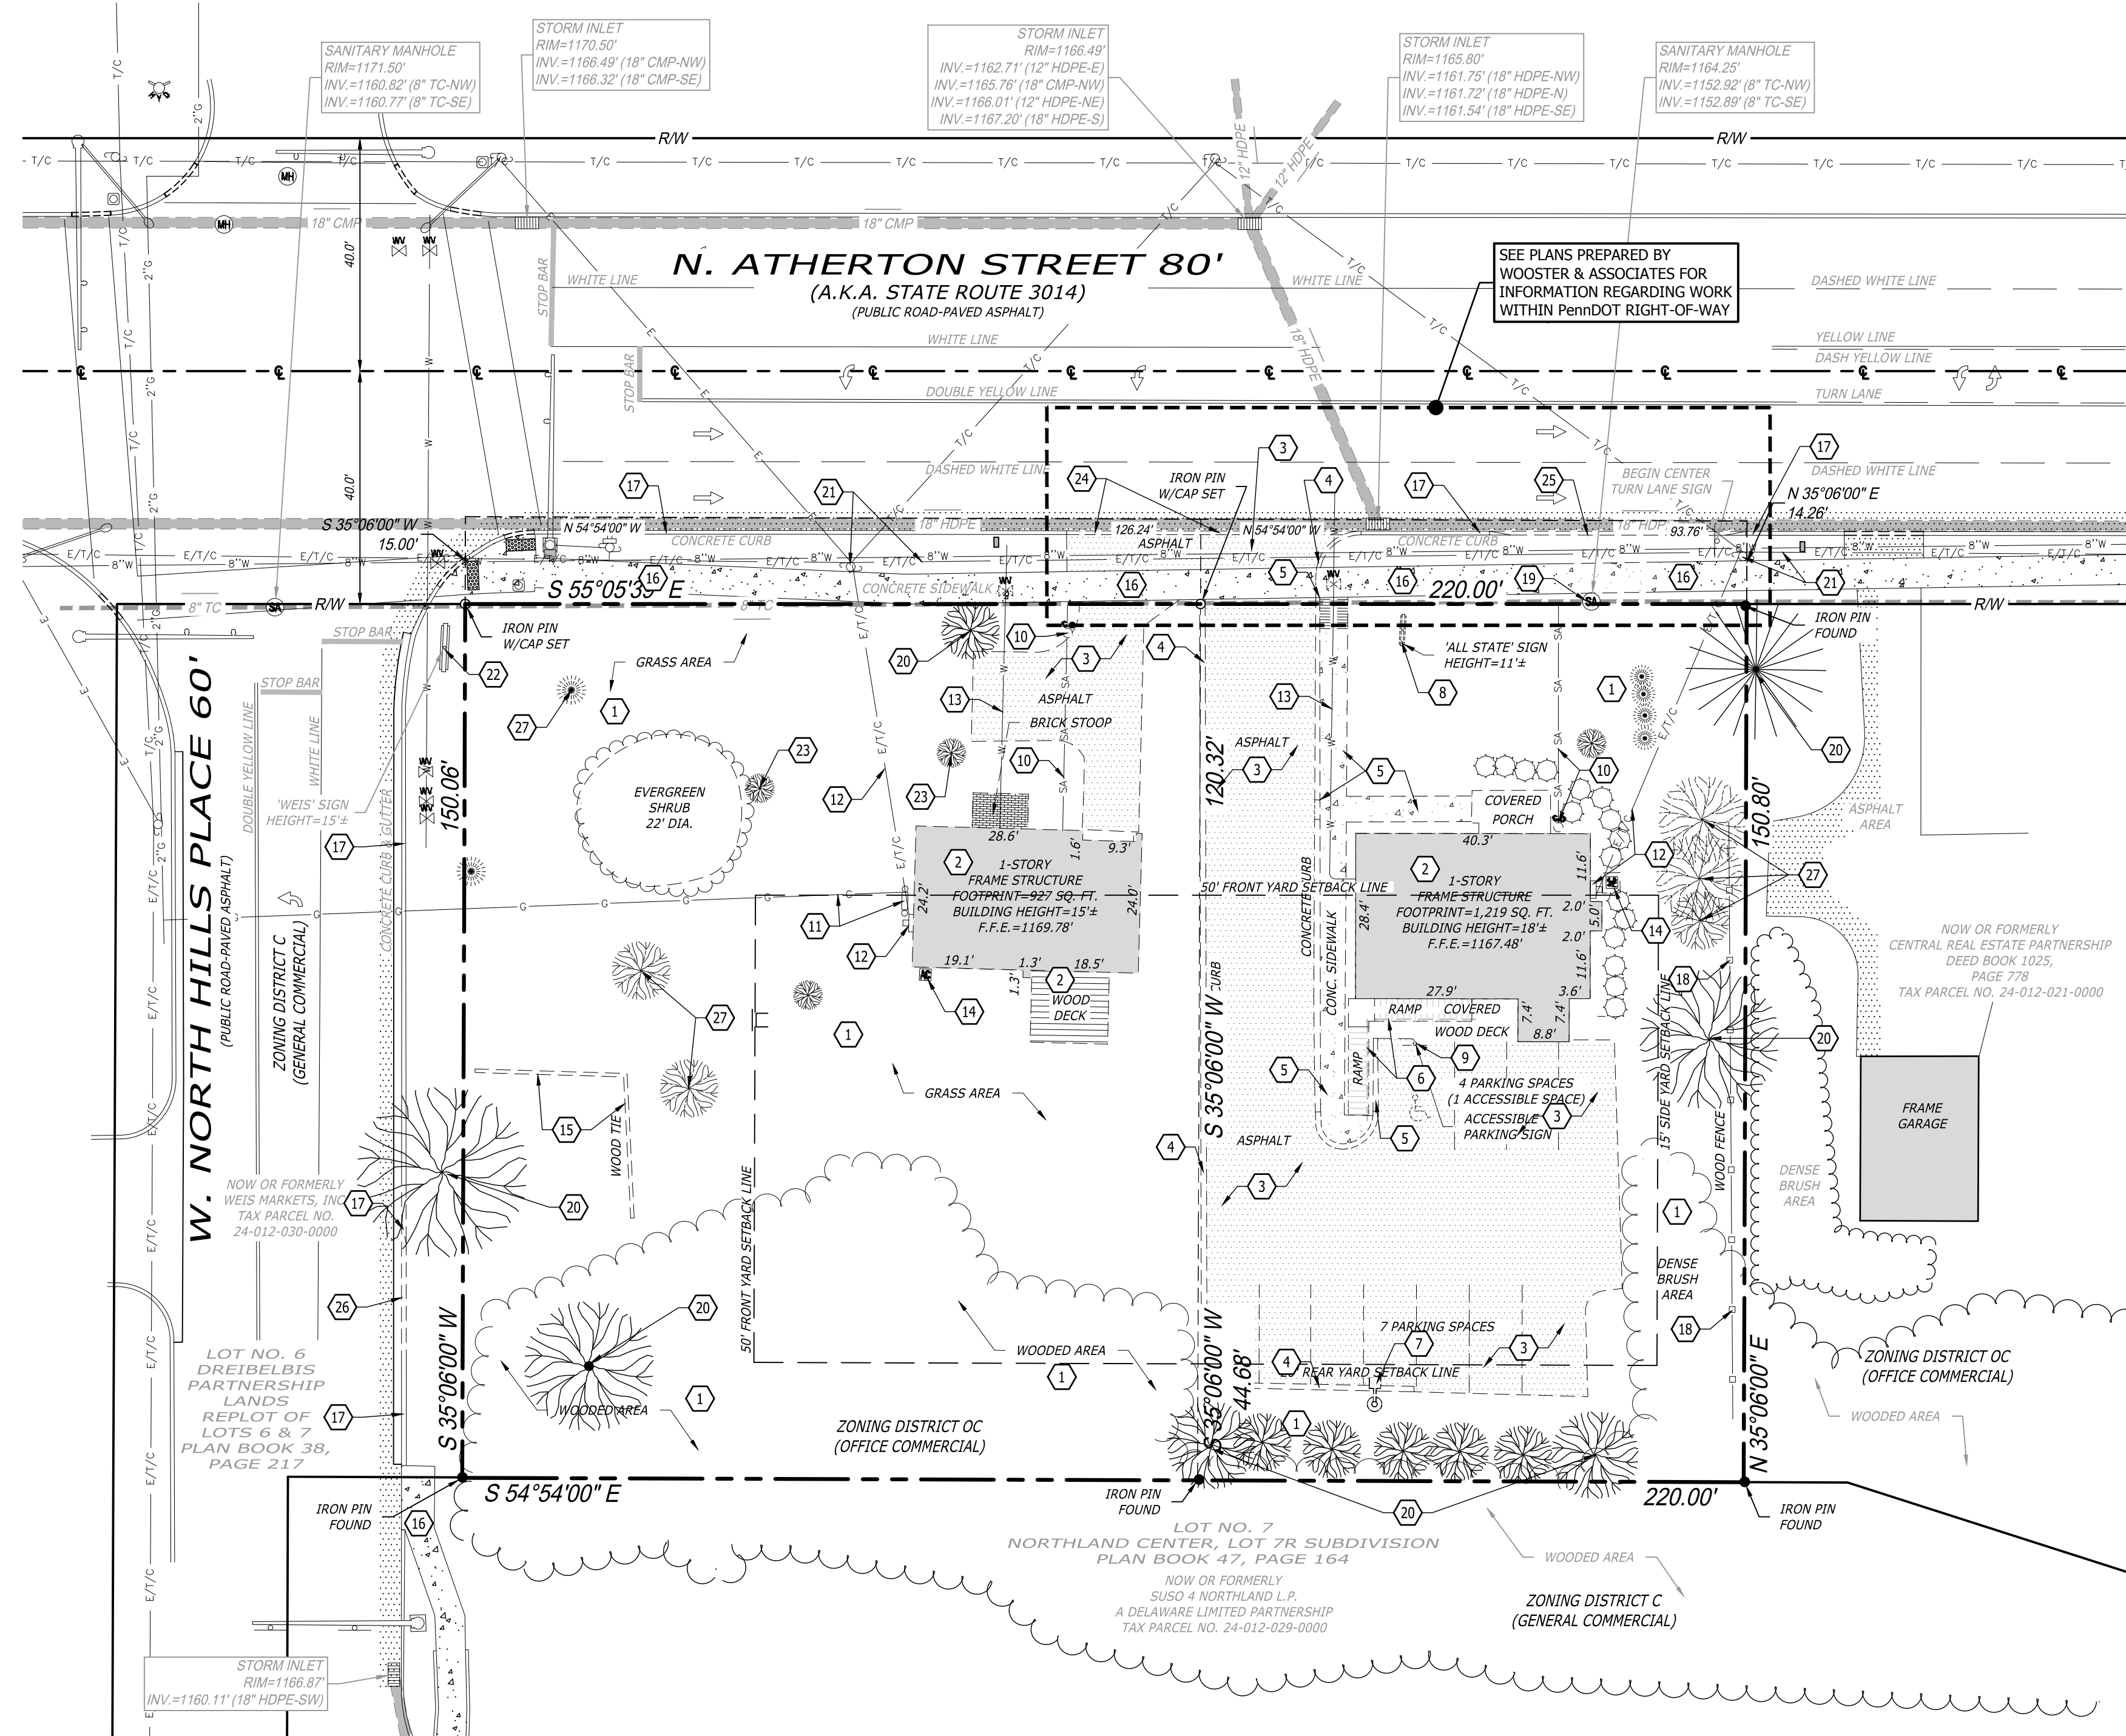


LEGEND OF SYMBOLS

Water Line	— W — W — W —	Iron Pin Found	⊕
Gas Line	— G — G — G —	Gas Meter	⊕
Overhead Electric, Telephone & Cable Line	— E/T/C — E/T/C —	Water Valve	⊕
Overhead Telephone & Cable Line	— T/C — T/C —	Fire Hydrant	⊕
Overhead Electric Line	— E — E — E —	Electric Meter	⊕
Storm Sewer	— S — S — S —	Utility Pole	⊕
Sanitary Sewer	— SS — SS — SS —	Guy Wire	⊕
Easements	— E — E — E —	AC Unit	⊕
Setback Line	— SL — SL — SL —	Traffic Light	⊕
Depressed Curb	— DC — DC — DC —	Traffic Flow Arrow	⊕
Wooden/Vinyl Fence	— WF — WF — WF —	Turn Arrows	⊕
Guard Rail	— GR — GR — GR —	Handicap Symbol	⊕
Tree Line	— TL — TL — TL —	Asphalt	⊕
Signal Poles	— SP — SP — SP —	Terra Cotta	⊕
Sign Poles	— SPO — SPO — SPO —	Polyvinyl Chloride	⊕
Street Light	— SL — SL — SL —	High Density Polyethylene	⊕
Iron Pin w/cap set (Unless Otherwise Noted)	⊕	Finished Floor Elevation	⊕
Sanitary Manhole	⊕	Corrugated Metal Pipe	⊕
Cleanout	⊕	Reinforced Concrete Pipe	⊕
Storm Manhole	⊕	Gravel	⊕
Manhole	⊕	Brick	⊕
Traffic Signal Base	⊕		
Sign	⊕		
Illuminated Signs	⊕		
Light Pole	⊕		
Benchmark	⊕		
Truncated Domes	⊕		
Right-of-Way	⊕		
Trees	⊕		

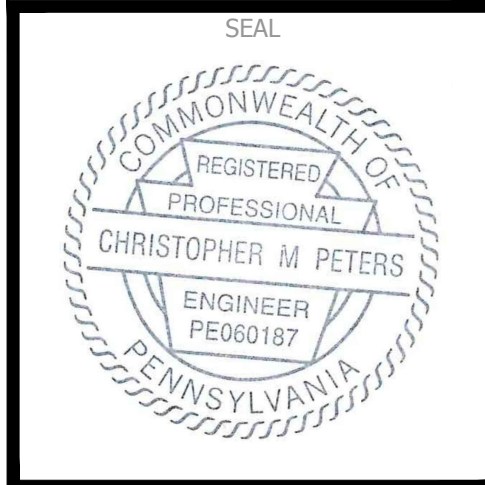


REV.	DATE	DESCRIPTION

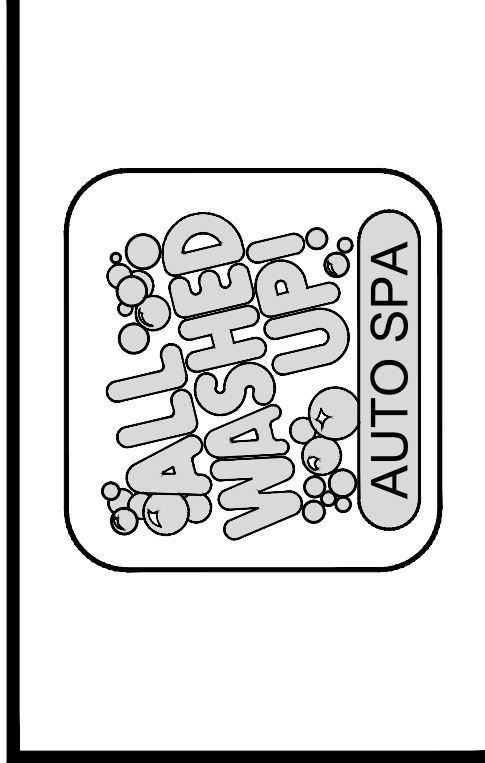

MIDM
SURVEYORS & ENGINEERS, LLC
Surveyors • Engineers • Site Planners
375 Northgate Drive
Warrendale, PA 15086
Ph: (724) 934-2810 Fax: (724) 934-2811
midm@aol.com midmllc.com www.midmllc.com

ALL WASHED UP AUTO SPA
PROJECT: 1380 & 1386 N. ATHERTON STREET
TOWNSHIP OF FERGUSON, COUNTY OF CENTRE
COMMONWEALTH OF PENNSYLVANIA


SHEET TITLE: **DEMOLITION PLAN**
DRAWN BY: CWT
CHECKED BY: CMP
ISSUE DATE: 8-29-2022
SHEET NUMBER: **SP-1**

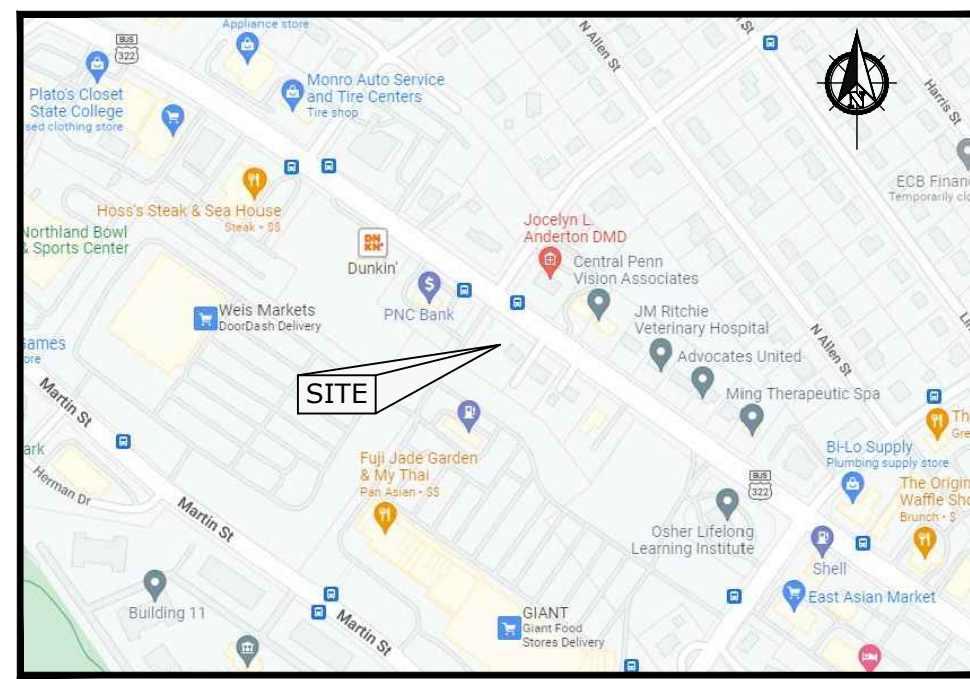

SITE LOCATION MAP
SCALE: 1" = 500'

Dig Serial No.: 20212860668
Design Serial No.: 20212860672

CALL BEFORE YOU DIG!
PENNSYLVANIA LAW REQUIRES
3 WORKING DAYS NOTICE FOR
CONSTRUCTION PHASE AND 10 WORKING
DAYS IN DESIGN STAGE - STOP CALL
PENNSYLVANIA ONE CALL SYSTEM, INC.
1-800-242-1776

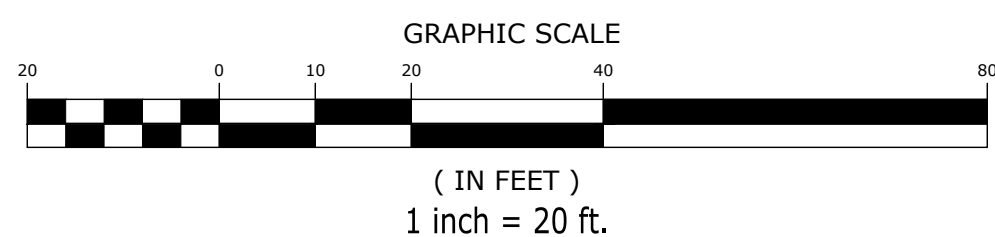


EXISTING IMPERVIOUS AREA, ADJUSTED TO 80% PER ORDINANCE:	8,950± SF
PROPOSED IMPERVIOUS COVERAGE:	23,195 SF
CAPTURE VOLUME REQUIREMENTS:	
0.25' / SQUARE FOOT FACILITIES:	485 c.f. ±
REPLICATION OF EXISTING STONE SUMP:	975 c.f. ±
TOTAL CAPTURE VOLUME REQUIRED:	~1,460 c.f.
PROPOSED CAPTURE FACILITIES:	
75 c.f. CISTERN COLLECTING ROOF DRAINAGE FOR CAR WASH RECIRCULATION.	
1,500 c.f. SUMP AT UNDERGROUND DETENTION SYSTEM.	
TOTAL CAPTURE PROPOSED:	1,575 c.f.


LEGEND OF SYMBOLS

Proposed Contour Line	1130	
Proposed High Point	H.P.	
Proposed Elevation	1129.50 TC 1129.00 BC	Top of Curb Bottom of Curb
	1128.62 TS 1128.50 BS	Top Surface of Concrete Asphalt Elevation at Edge of Concrete
Proposed Storm Inlet	[Symbol]	
Proposed Storm Line	[Symbol]	
Contour Line	1165	
Water Line	W	
Gas Line	G	
Overhead Electric, Telephone & Cable Line	E/T/C	
Overhead Telephone & Cable Line	T/C	
Overhead Electric Line	E	
Storm Sewer	[Symbol]	
Sanitary Sewer	[Symbol]	
Easements	[Symbol]	
Setback Line	[Symbol]	
Depressed Curb	[Symbol]	
Wooden/Vinyl Fence	[Symbol]	
Guard Rail	[Symbol]	
Tree Line	[Symbol]	
Signal Poles	[Symbol]	
Sign Poles	[Symbol]	
Street Light	[Symbol]	
Iron pin w/cap set (Unless otherwise noted)	[Symbol]	Iron Pin Found
Sanitary Manhole	[Symbol]	Gas Meter
Cleanout	[Symbol]	Gas Valve
Storm Manhole	[Symbol]	Water Valve
Storm Inlet	[Symbol]	Fire Hydrant
Manhole	[Symbol]	Electric Meter
Traffic Signal Base	[Symbol]	Utility Pole
Sign	[Symbol]	Guy Wire
Illuminated Signs	[Symbol]	AC Unit
Light Pole	[Symbol]	Traffic Light
Benchmark	[Symbol]	Traffic Flow Arrow
Truncated Domes	[Symbol]	Turn Arrows
Right-of-Way	R/W	Handicap Symbol
Shrub	[Symbol]	Trees
Spot Elevation	+1165.07	
Existing Curb Elevations:		Asphalt
TC=Top of Curb		Concrete
FC=Bottom of Curb		Gravel
Terra Cotta	T.C.	Brick
PVC	PVC	
High Density Polyethylene	HDPE	
Finished Floor Elevation	F.F.E.	
Corrugated Metal Pipe	CMP	
Reinforced Concrete Pipe	RCP	


GRADING & DRAINAGE NOTES

- SEE SITE PLAN FOR ADDITIONAL GENERAL NOTES.
- ALL SITE WORK, MATERIALS OF CONSTRUCTION, AND CONSTRUCTION METHODS SHALL COMPLY WITH LOCAL MUNICIPALITY, LOCAL COUNTY, AND DEPARTMENT OF TRANSPORTATION MATERIAL AND CONSTRUCTION SPECIFICATIONS.
- THE CONTRACTOR IS SOLELY RESPONSIBLE FOR DETERMINING ACTUAL LOCATIONS AND ELEVATIONS OF ALL UTILITIES, INCLUDING SERVICES. PRIOR TO CONSTRUCTION, THE CONTRACTOR SHALL CONTACT THE PA ONE CALL SYSTEM AT 1-800-242-1776 AT LEAST THREE (3) WORKING DAYS BEFORE START OF WORK AND VERIFY ALL EXISTING UTILITY LOCATIONS.
- ALL PIPES SHALL BE LAID ON STRAIGHT ALIGNMENTS AND EVEN GRADES USING A PIPE LASER OR OTHER ACCURATE METHOD.
- THE CONTRACTOR SHALL COMPACT PIPE BACKFILL IN MAX. 8" LOOSE LIFTS TO 95% OF THE MAXIMUM DRY DENSITY PER ASTM D1557, ACCORDING TO THE PIPE BEDDING DETAILS. TRENCH BOTTOM SHALL BE STABLE IN HIGH GROUNDWATER AREAS. A PIPE FOUNDATION SHALL BE USED IN AREAS OF ROCK EXCAVATION.
- CONTRACTOR SHALL PROVIDE ALL BENDS, FITTINGS, ADAPTERS, ETC., AS REQUIRED FOR PIPE CONNECTIONS TO BUILDING/CANOPY STUB-OUTS, INCLUDING ROOF/FOOTING DRAIN CONNECTIONS TO ROOF LEADERS AND TO STORM DRAINAGE SYSTEM.
- TOPSOIL SHALL BE STRIPPED AND STOCKPILED FOR USE IN FINAL LANDSCAPING.
- MANHOLE RIMS AND STORM INLET GRATES SHALL BE SET TO ELEVATIONS SHOWN. SET ALL EXISTING MANHOLE FRAMES AND COVERS, STORM INLET GRATES, VALVE BOXES, ETC., TO BE RAISED OR LOWERED, TO PROPOSED FINISHED GRADE, FLUSH WITH THE ADJACENT GRADE.
- UNDERDRAINS MAY BE ADDED, IF DETERMINED NECESSARY BY THE ENGINEER OR CONSTRUCTION MANAGER, AFTER SUBGRADE IS ROUGH GRADED.
- ALL EXISTING TOPOGRAPHICAL FEATURES (SPOT ELEVATIONS, CONTOURS, INVERTS, ETC.) CAN HAVE A TOLERANCE DIFFERENCE OF 6"± DEPENDING ON FIELD CONDITIONS AT THE TIME OF THE FIELD SURVEY. CONTRACTOR TO VERIFY ALL EXISTING TOPOGRAPHICAL FEATURES PRIOR TO CONSTRUCTION, AND ADVISE OWNER OF ANY DISCREPANCIES.
- THE CONTRACTOR SHALL RESTORE ANY STRUCTURE, PIPE, UTILITY, PAVEMENT, CURBS, SIDEWALKS, LANDSCAPED AREAS, ETC. DISTURBED DURING CONSTRUCTION TO THE ORIGINAL CONDITION OR BETTER.
- THE CONTRACTOR SHALL SUBMIT SHOP DRAWINGS OF MATERIALS AND STRUCTURES TO THE CONSTRUCTION MANAGER FOR REVIEW AND APPROVAL PRIOR TO FABRICATION.
- THE CONTRACTOR SHALL PRESERVE EXISTING VEGETATION WHERE POSSIBLE AND/OR AS NOTED ON DRAWINGS. REFER TO EROSION AND SEDIMENTATION PLAN FOR LIMIT OF DISTURBANCE AND NOTES.
- THE CONTRACTOR SHALL COMPACT FILL IN 8" MAXIMUM LIFTS UNDER ALL PARKING, BUILDING, AND DRIVE AREAS TO 95% OF THE MAXIMUM DRY DENSITY AS DETERMINED BY ASTM D1557 (MODIFIED PROCTOR TEST), OR AS DIRECTED BY THE GEOTECHNICAL ENGINEER.
- THE CONTRACTOR IS RESPONSIBLE FOR THE REMOVAL AND DISPOSAL OF ALL RUBBISH, TRASH, DEBRIS, AND ORGANIC MATERIAL IN A LAWFUL MANNER.
- THE CONTRACTOR SHALL BE ADVISED THAT ALL EXCAVATION IS CONSIDERED UNCLASSIFIED AND THAT IT SHALL BE RESPONSIBLE FOR ALL MEANS, METHODS, AND MATERIALS OF CONSTRUCTION TO COMPLETE CONSTRUCTION AS DESIGNED. ADDITIONALLY, THE CONTRACTOR SHALL BE RESPONSIBLE FOR THE OFF-SITE DISPOSAL OF ANY AND ALL EXCESS OR UNSUITABLE MATERIAL UNABLE TO BE PLACED ON SITE AND THE IMPORTATION OF ANY BORROW MATERIAL NECESSARY TO COMPLETE THE JOB.
- ALL EXCAVATION AND GRADING CONSTRUCTION SHALL BE PERFORMED IN ACCORDANCE WITH THE GEOTECHNICAL ENGINEERING REPORT.
- SITE GRADING SHALL BE PERFORMED TO PROVIDE POSITIVE DRAINAGE TO STORM INLETS AND TO PRECLUDE THE PONDING OF WATER ON SITE.
- VERIFY REQUIRED SPOT ELEVATIONS/GRADING IN THE VICINITY OF THE BUILDINGS WITH THE ARCHITECTURAL PLANS.
- ALL ACCESSIBLE PARKING SPACES TO HAVE A MAXIMUM SLOPE OF 2% IN ANY DIRECTION.
- ALL SIDEWALKS AND ACCESSIBLE ROUTES TO THE BUILDING ARE TO HAVE A MAXIMUM CROSS SLOPE OF 2%, AND A MAXIMUM LONGITUDINAL SLOPE OF 5%.
- CONTRACTOR TO FIELD VERIFY PROPOSED AND EXISTING GRADES, SLOPES, ETC., FOR PROPOSED ACCESSIBLE PARKING AREAS, RAMP, ETC., WITH ARCHITECT, PRIOR TO CONSTRUCTION.
- LOCATIONS OF EXISTING UNDERGROUND UTILITIES ARE TAKEN FROM FIELD OBSERVATION, UTILITY MAPS, ETC., AND ARE NOT ASSUMED TO BE ACCURATE. PRIOR TO ANY CONSTRUCTION ACTIVITIES, CONTRACTOR TO DIG TEST PITS AT ALL PROPOSED UTILITY CROSSINGS, TO VERIFY LOCATION, DEPTH, SIZE, ETC. OF EXISTING UNDERGROUND UTILITIES, AND CONFIRM NEW UTILITY LINES CAN BE INSTALLED AS PROPOSED, ADVISE CONSTRUCTION MANAGER IMMEDIATELY OF ANY CONFLICTS OR DISCREPANCIES.

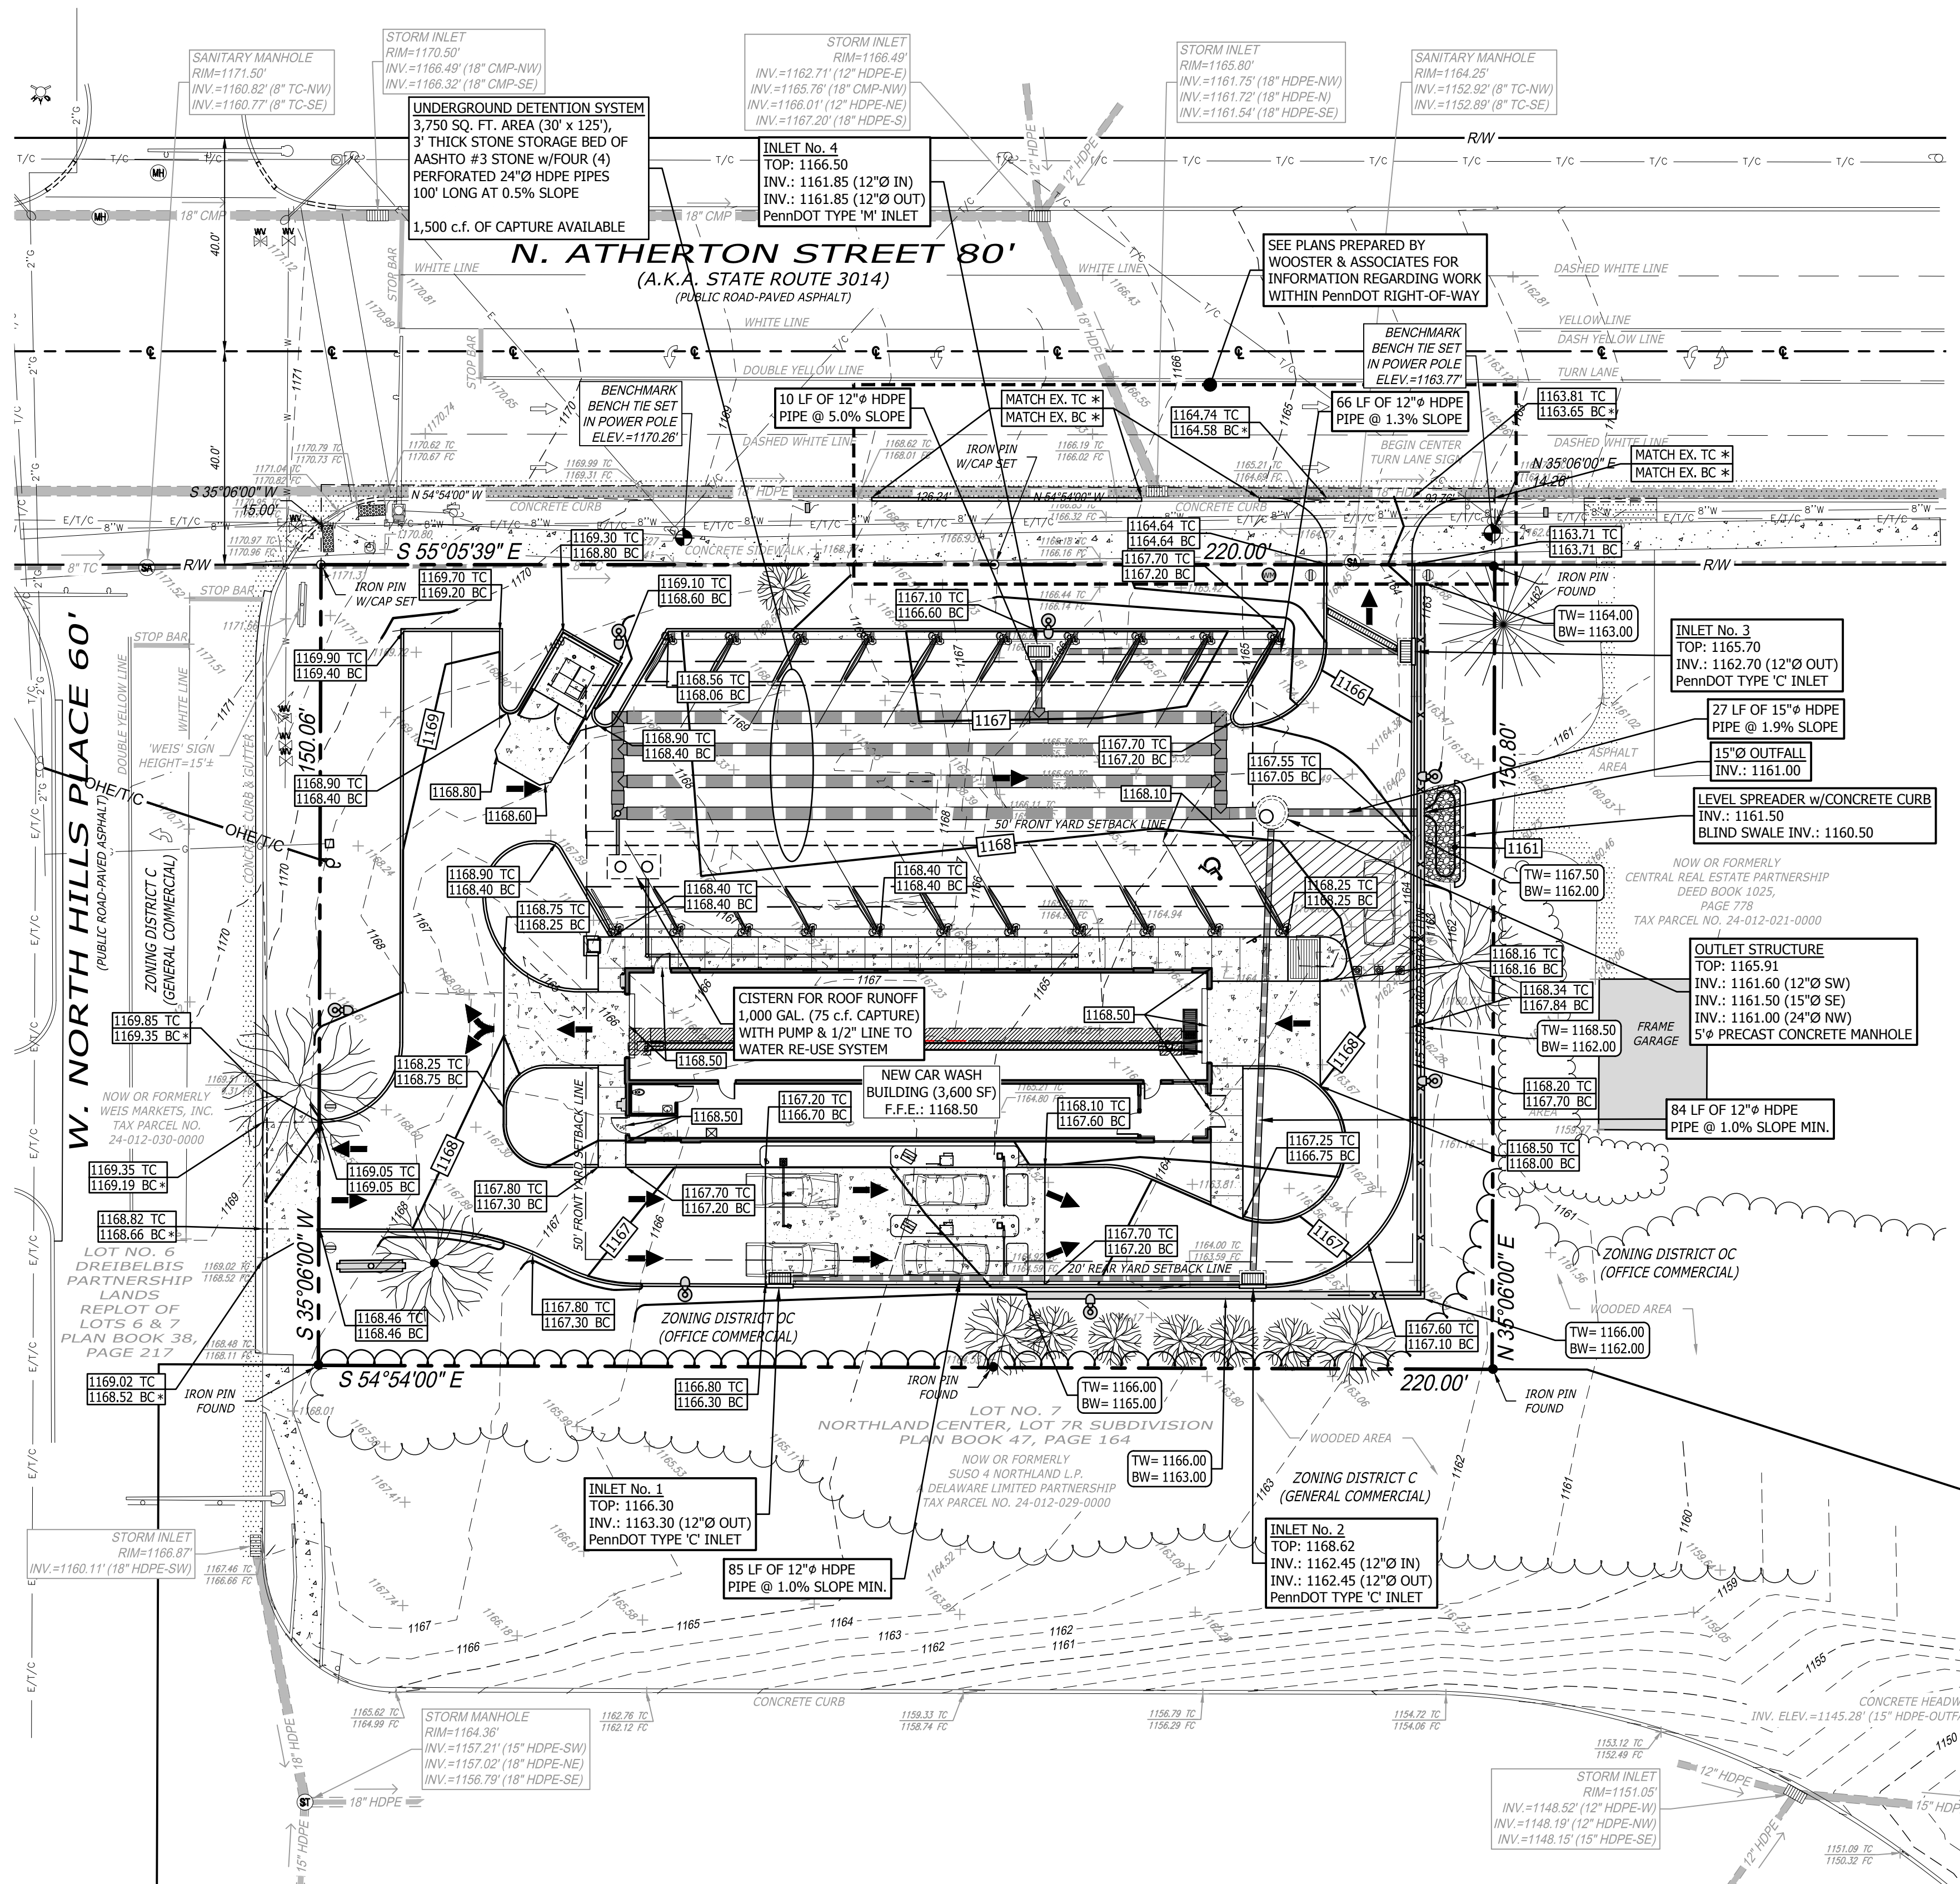


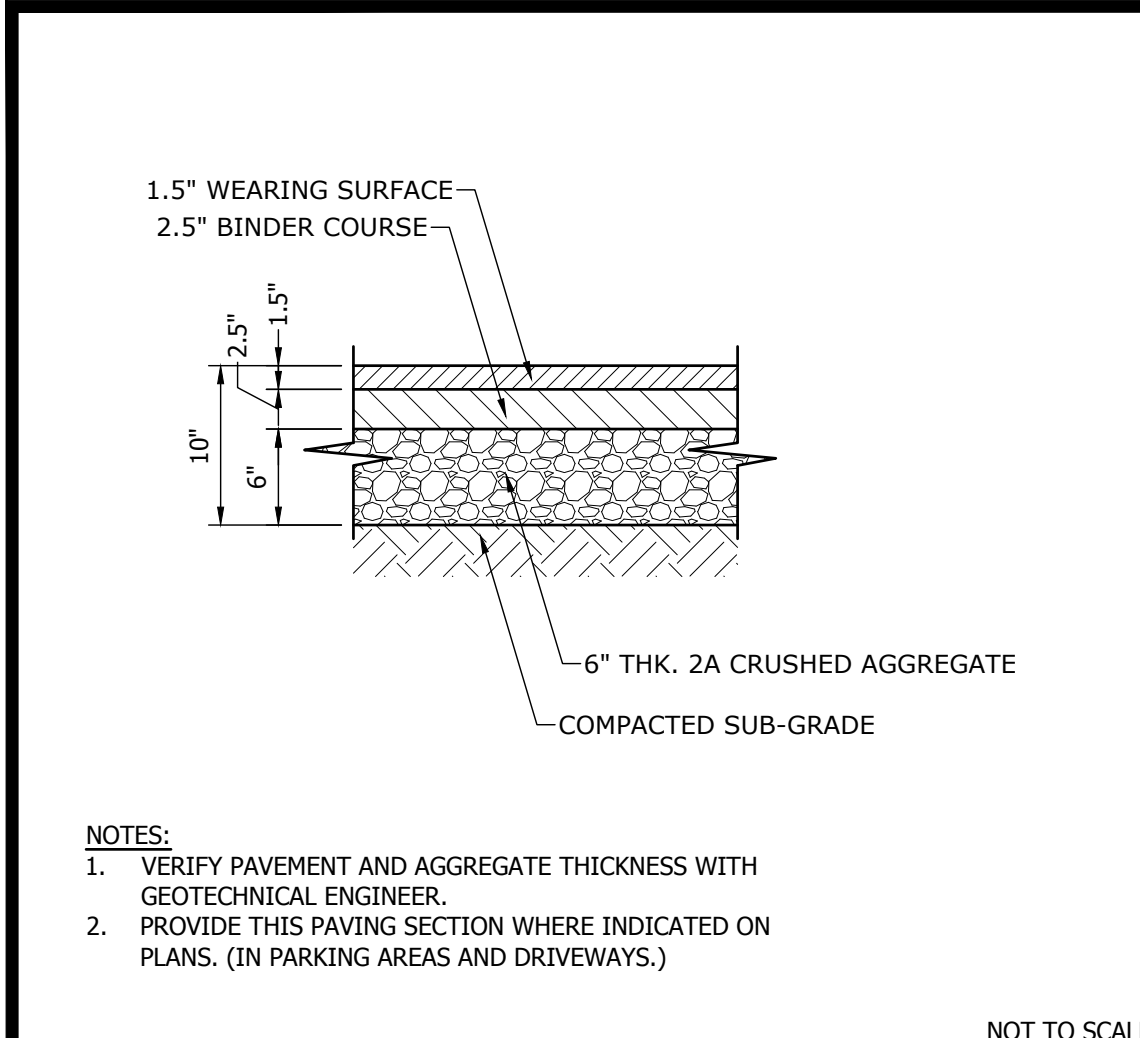


1 ASPHALT PAVEMENT SECTION

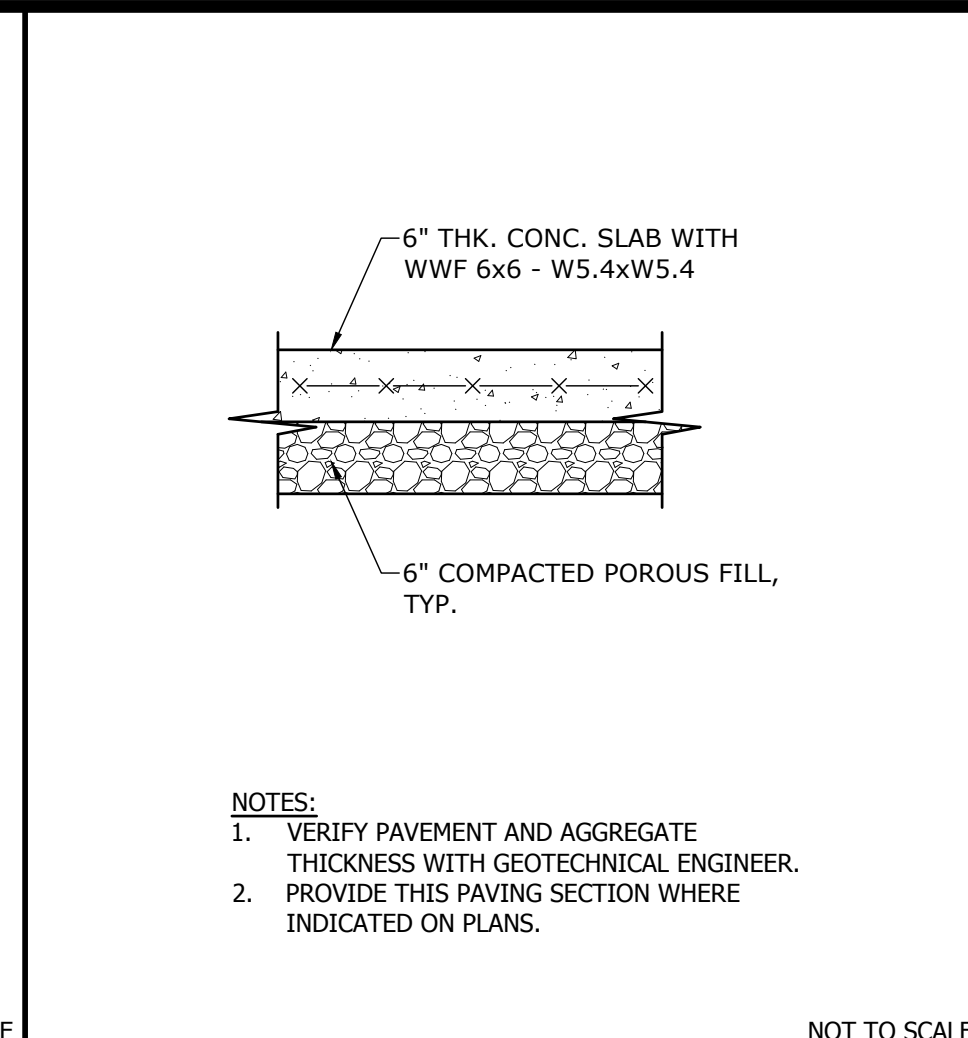


2 CONCRETE PAVEMENT SECTION

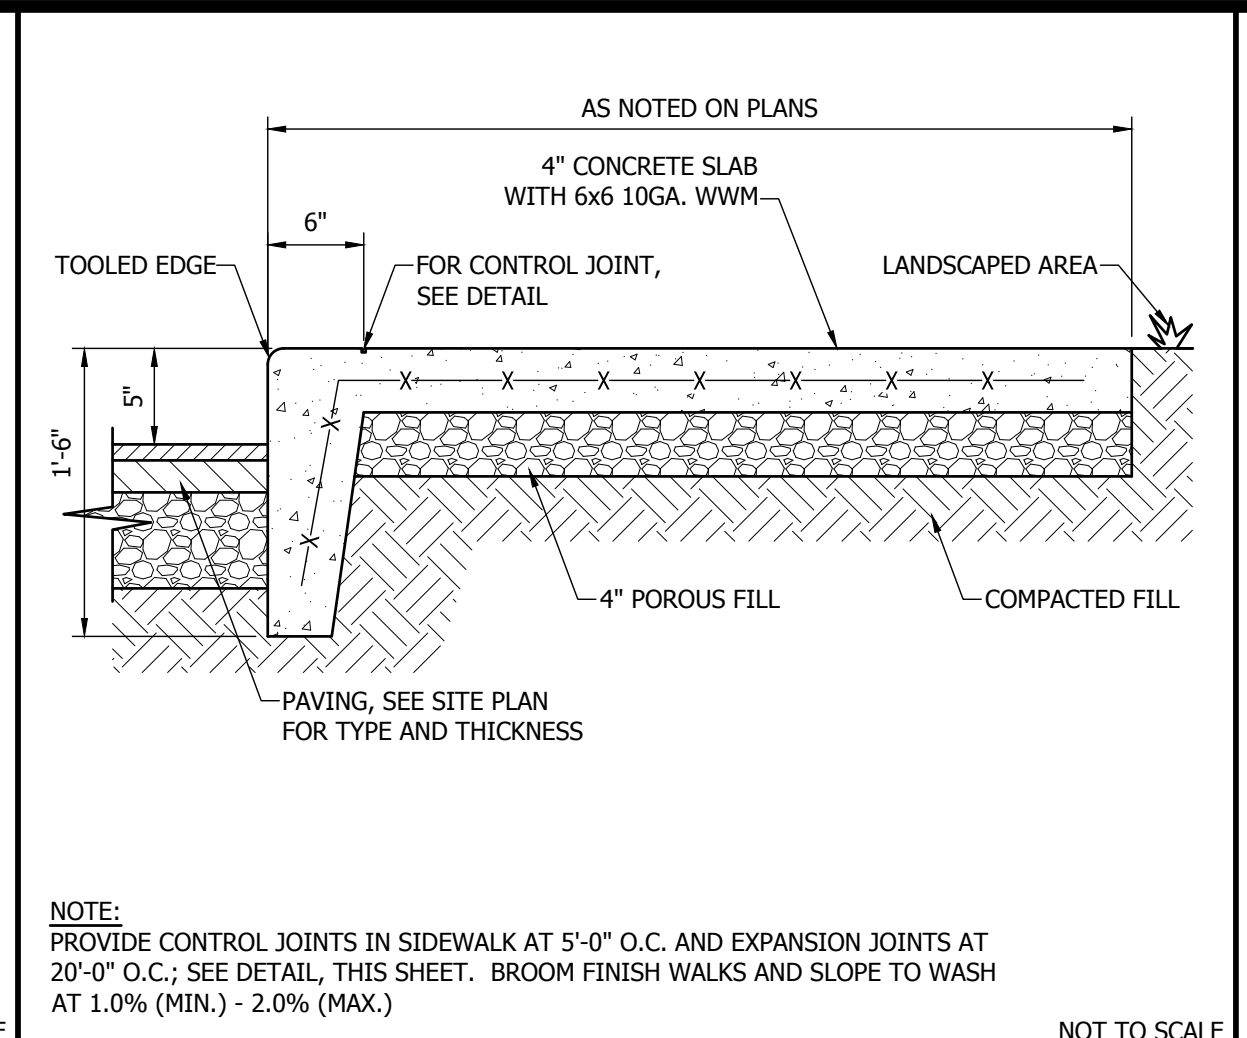


3 MONOLITHIC CONCRETE SIDEWALK

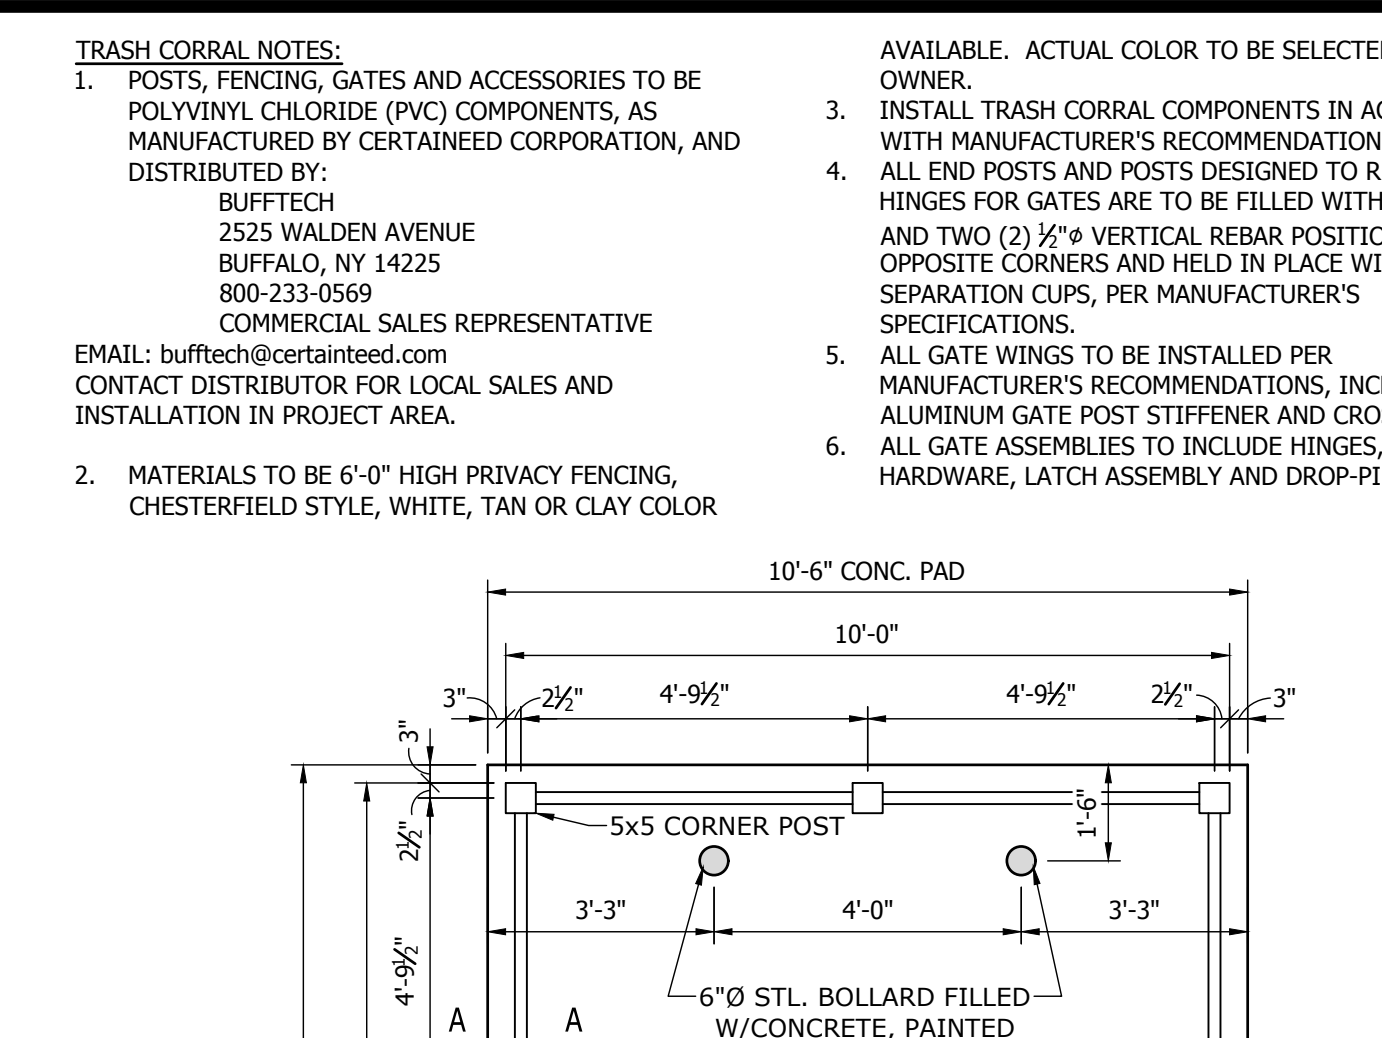


7 TRASH CORRAL DETAIL

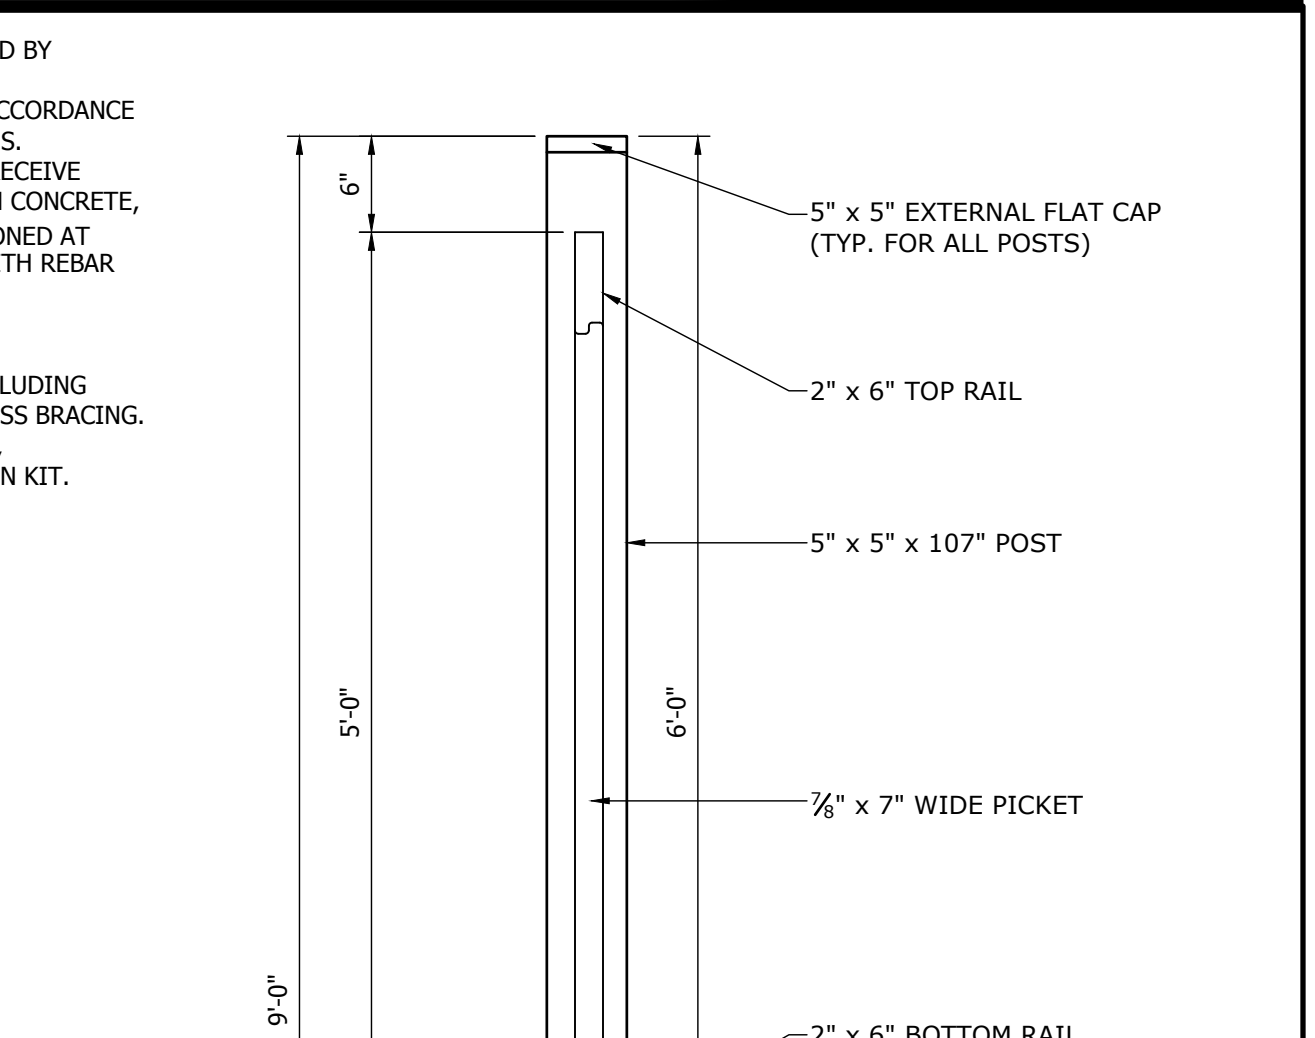


SECTION A-A

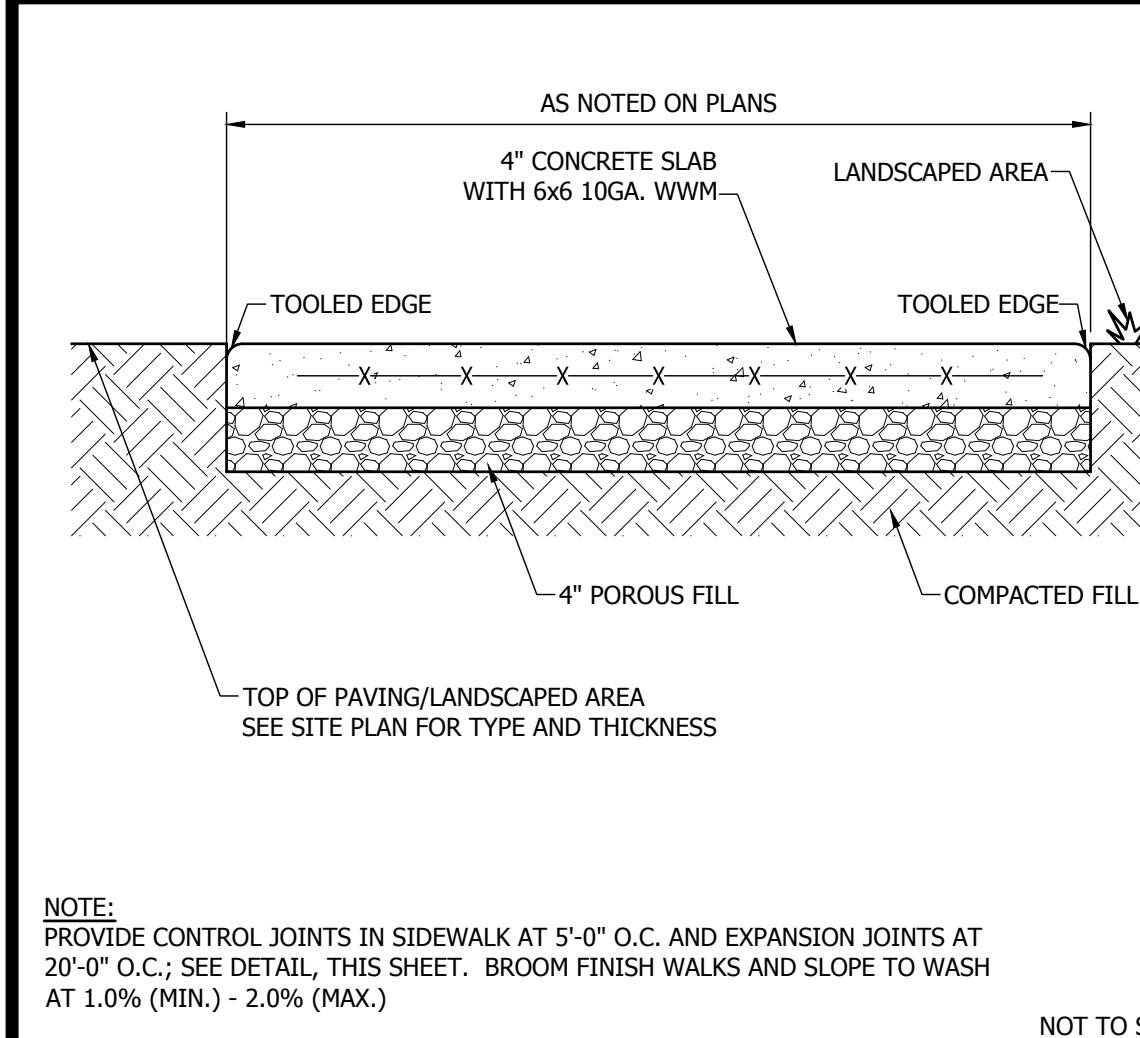


4 CONCRETE SIDEWALK DETAIL

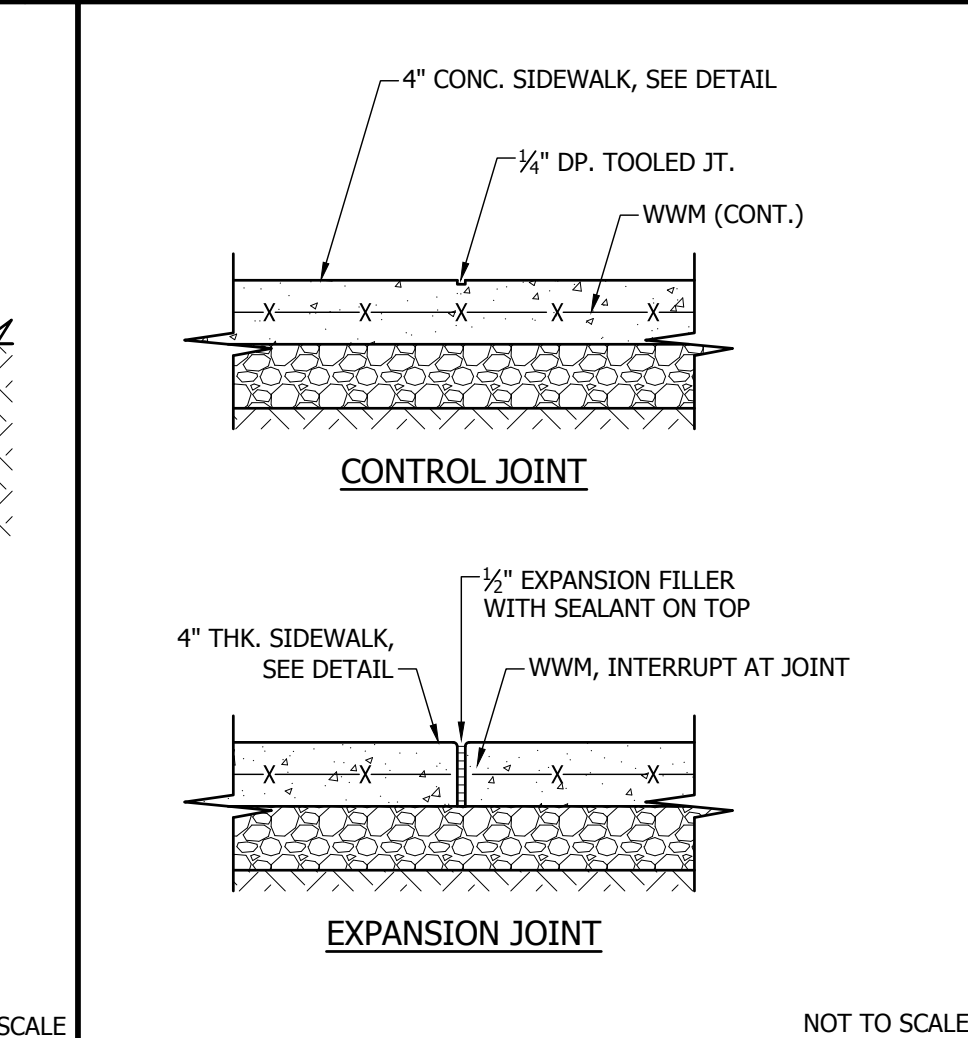


5 EXPANSION AND CONTROL JOINTS

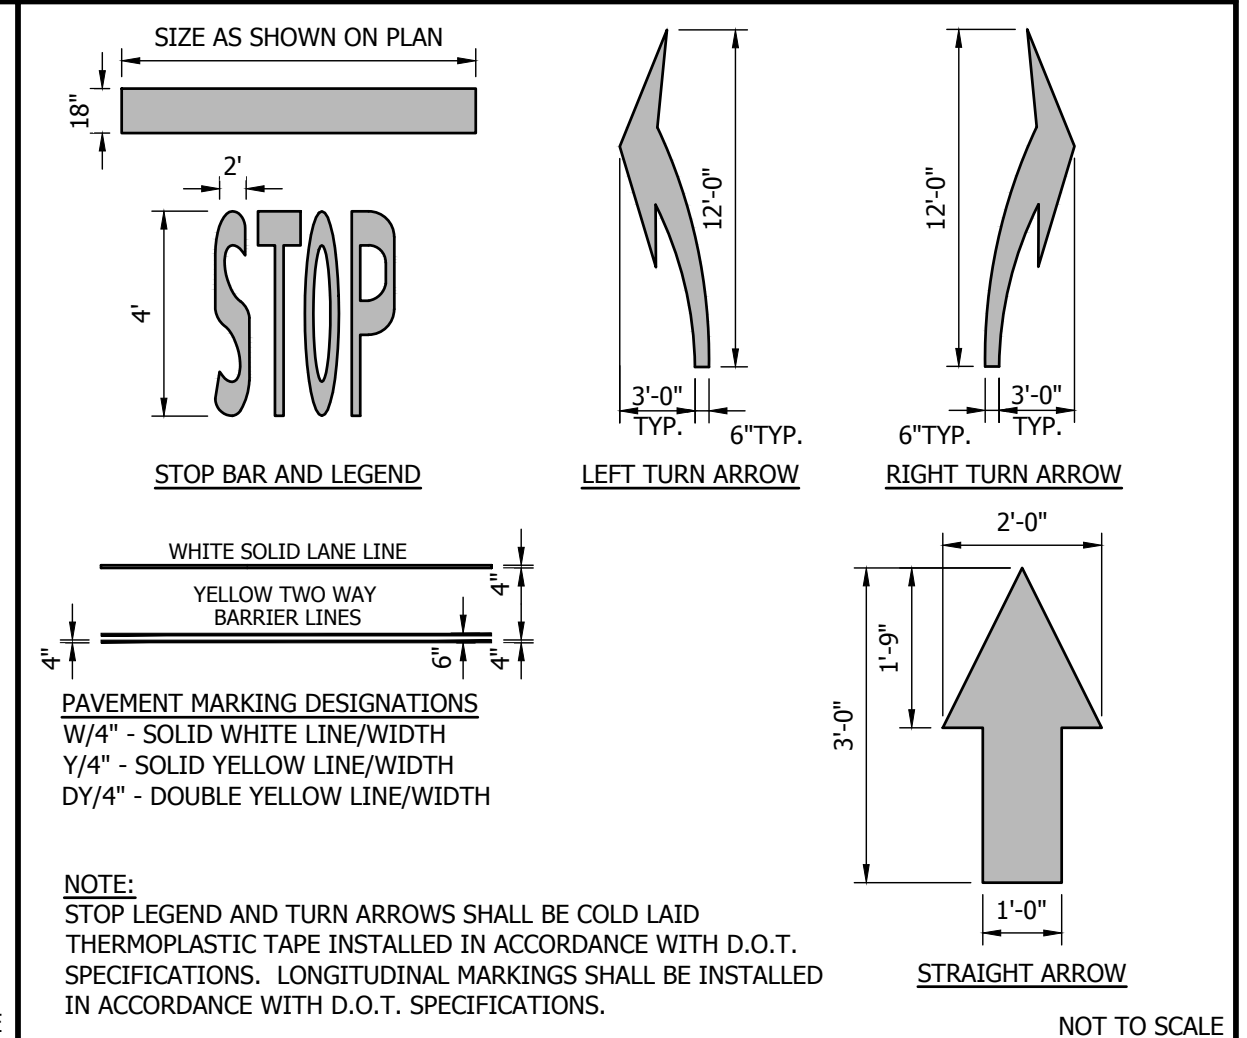


6 PAVEMENT MARKINGS

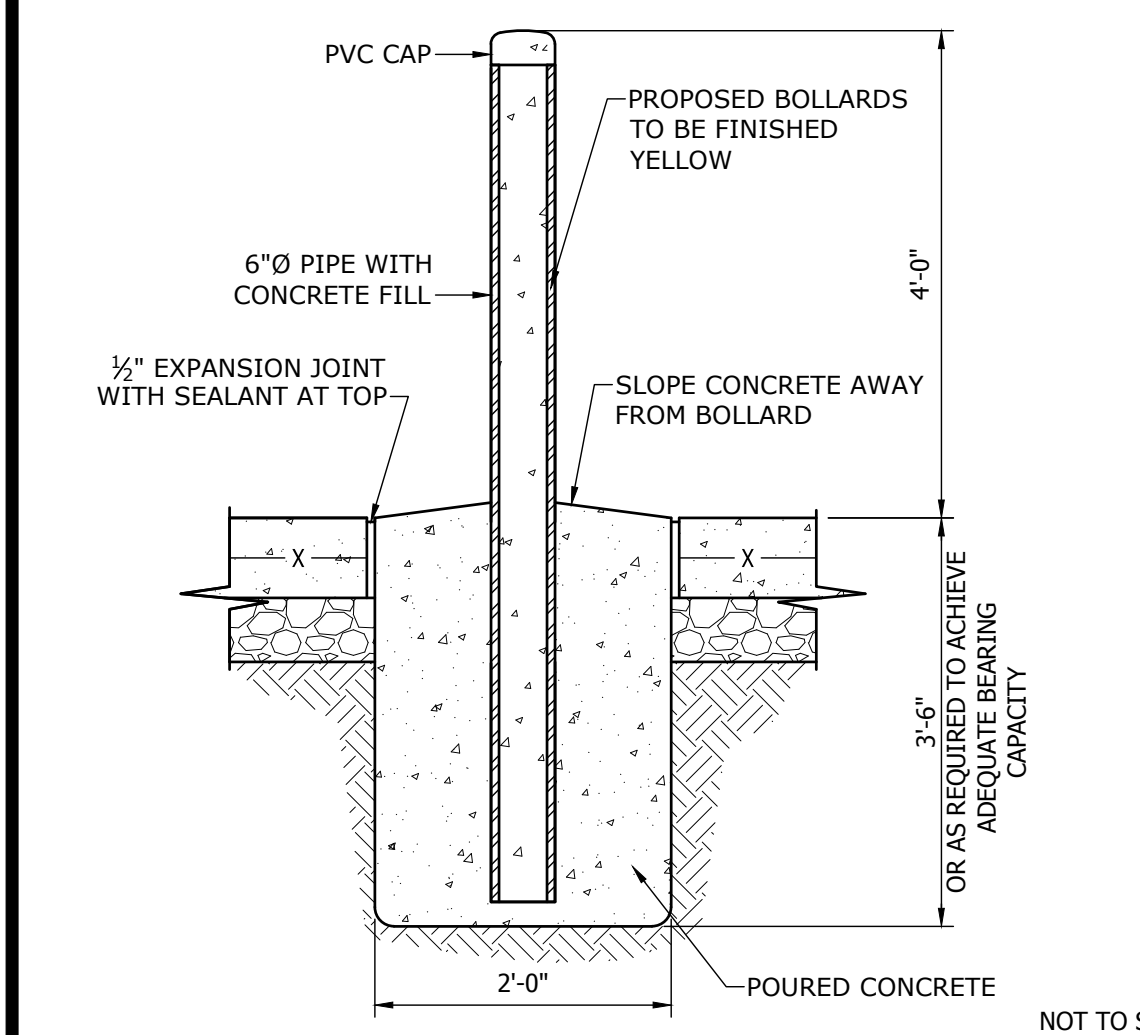


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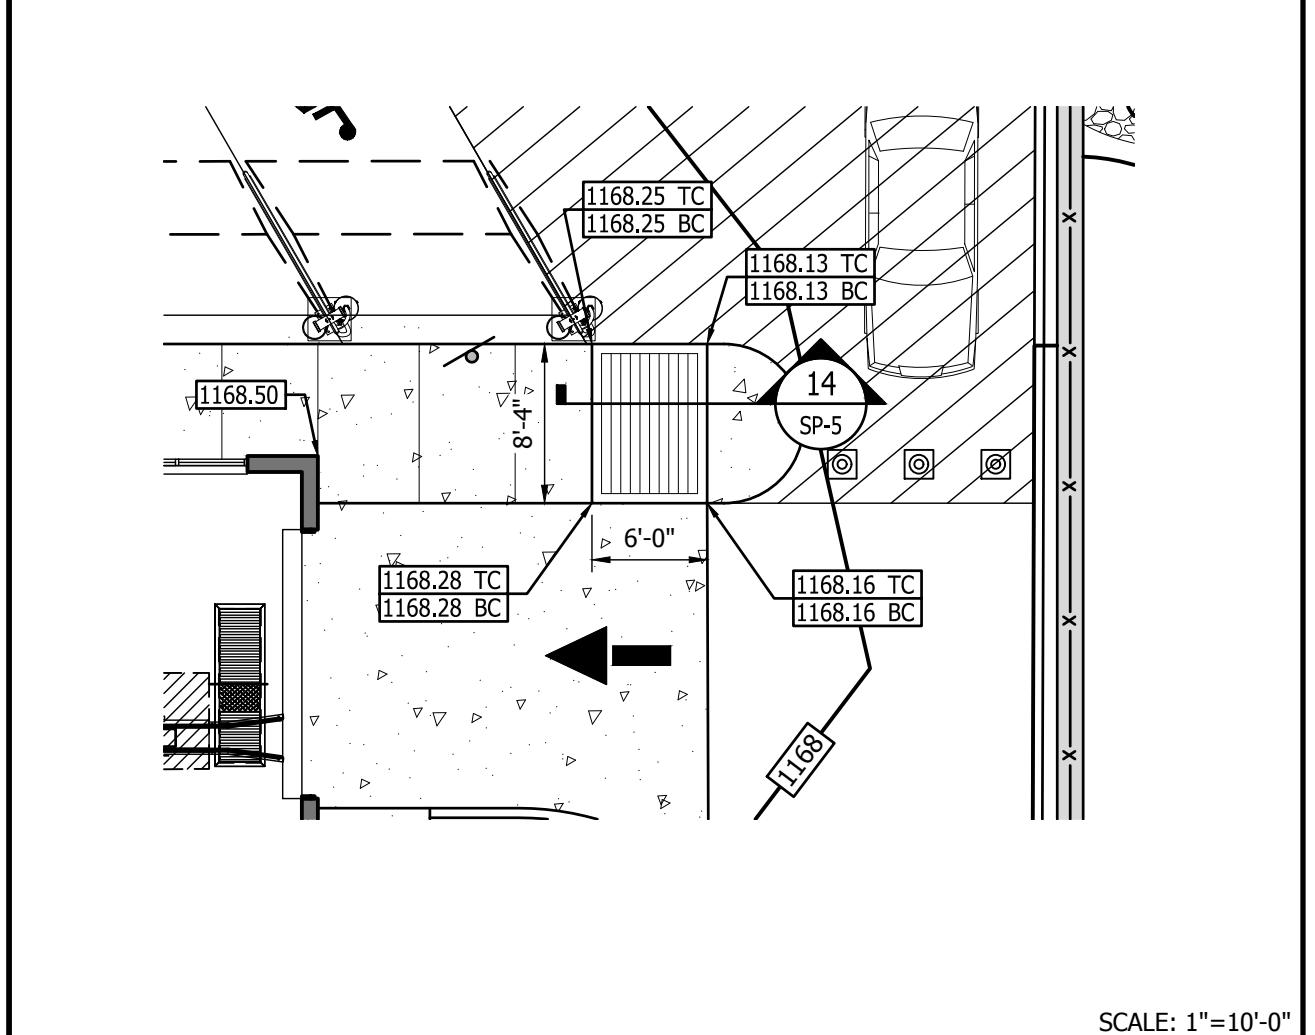
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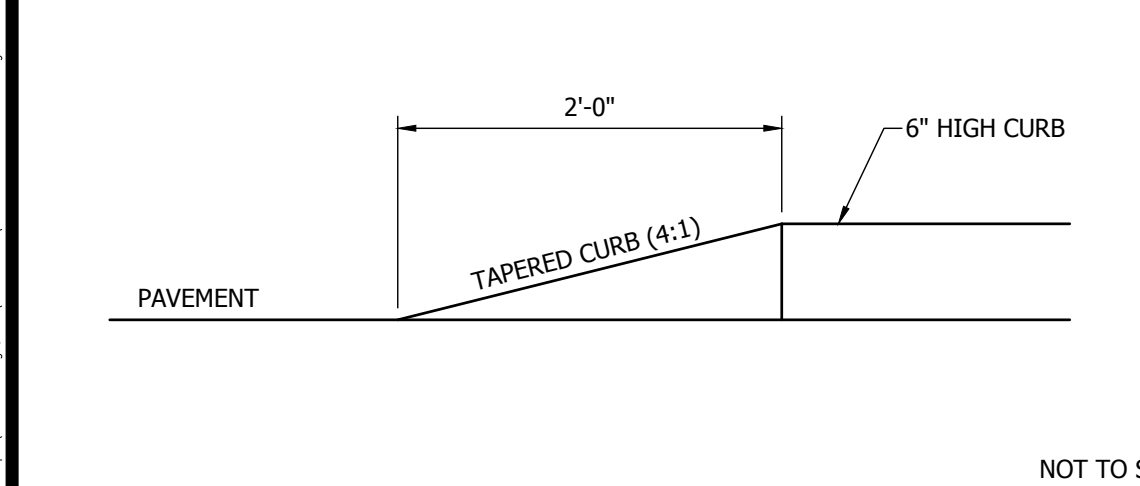
10 POURED-IN-PLACE CONCRETE RETAINING WALL

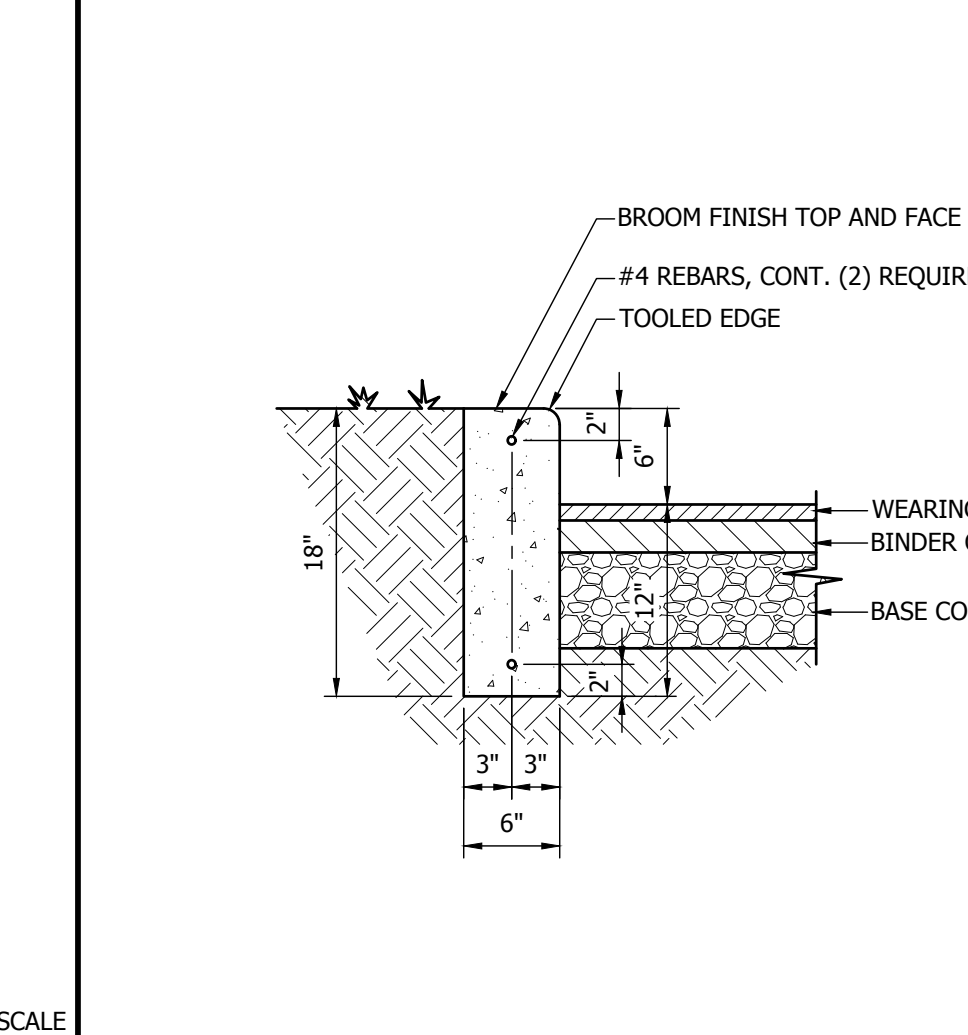


11 PEDESTRIAN SAFETY RAILING

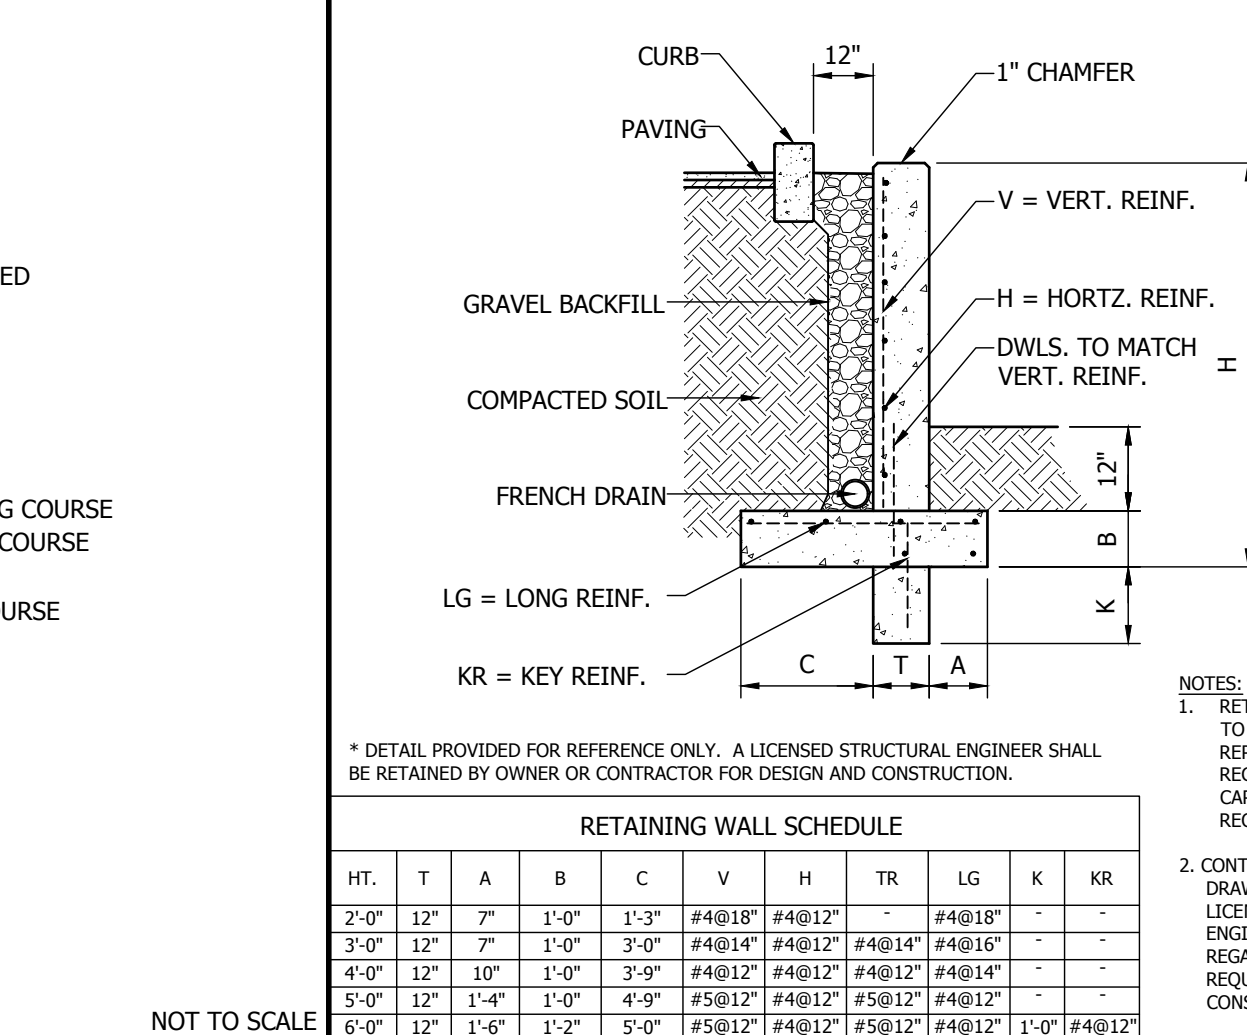


12 RAMP DETAIL @ ACCESSIBLE PARKING

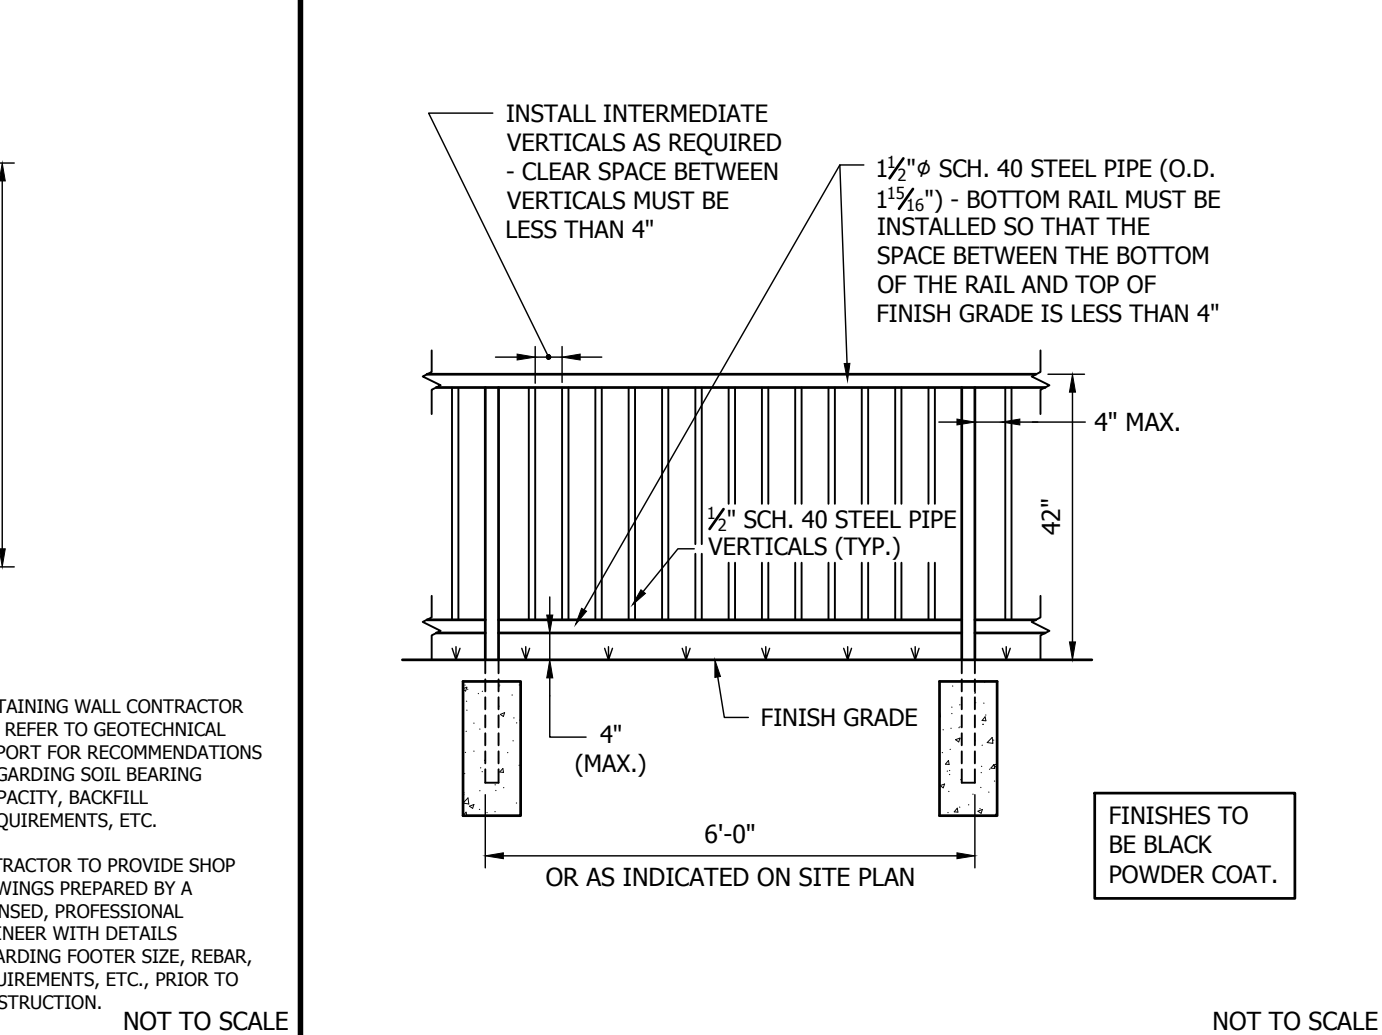


13 TAPER END OF CURB

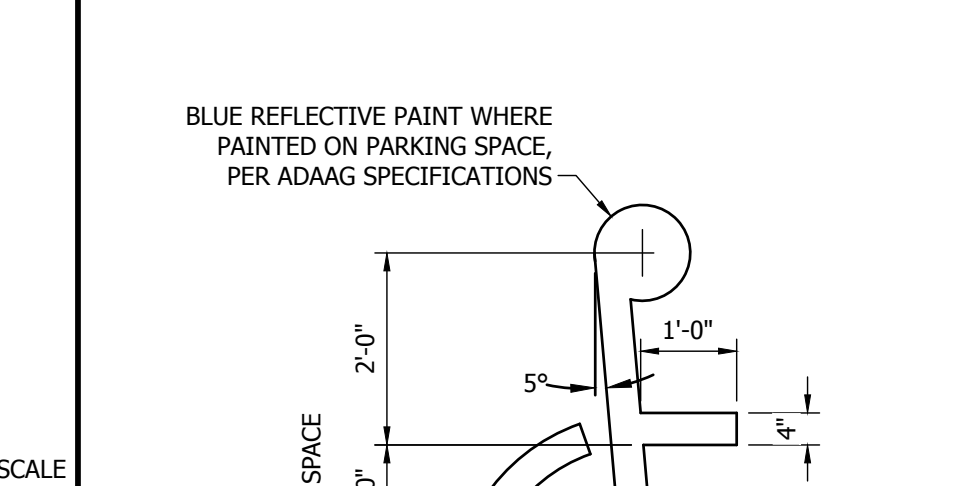


15 PAINTED ACCESSIBLE PARKING SYMBOL

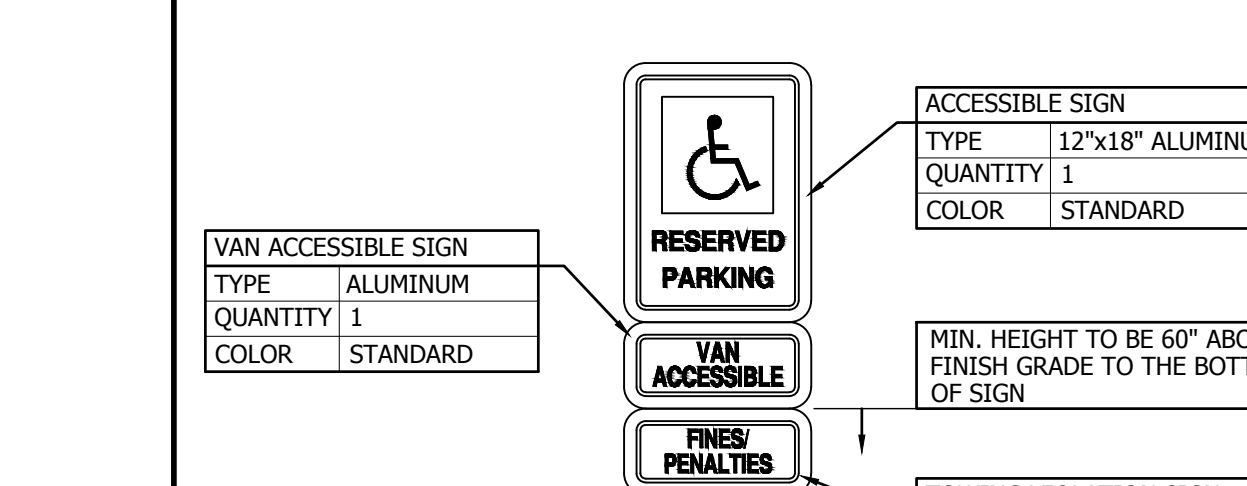


16 ACCESSIBLE PARKING SIGN

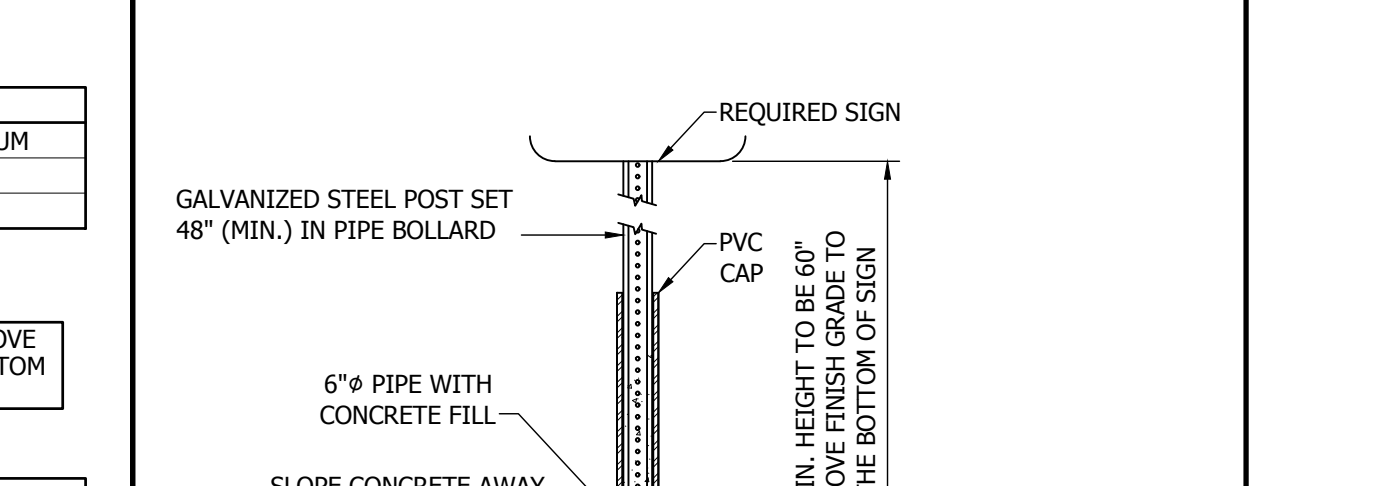


17 GUARD POST

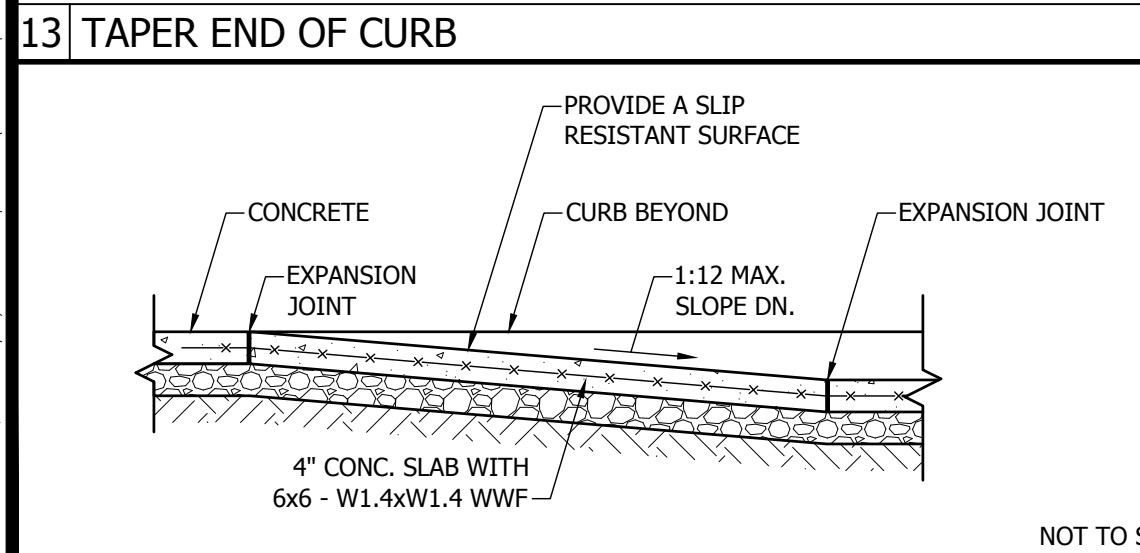


14 SECTION @ RAMP

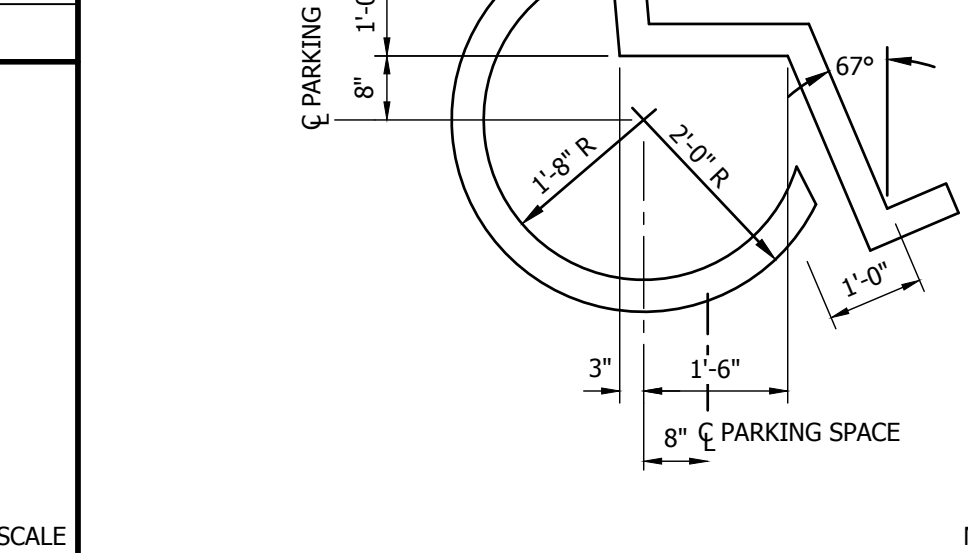

4 CONCRETE SIDEWALK DETAIL

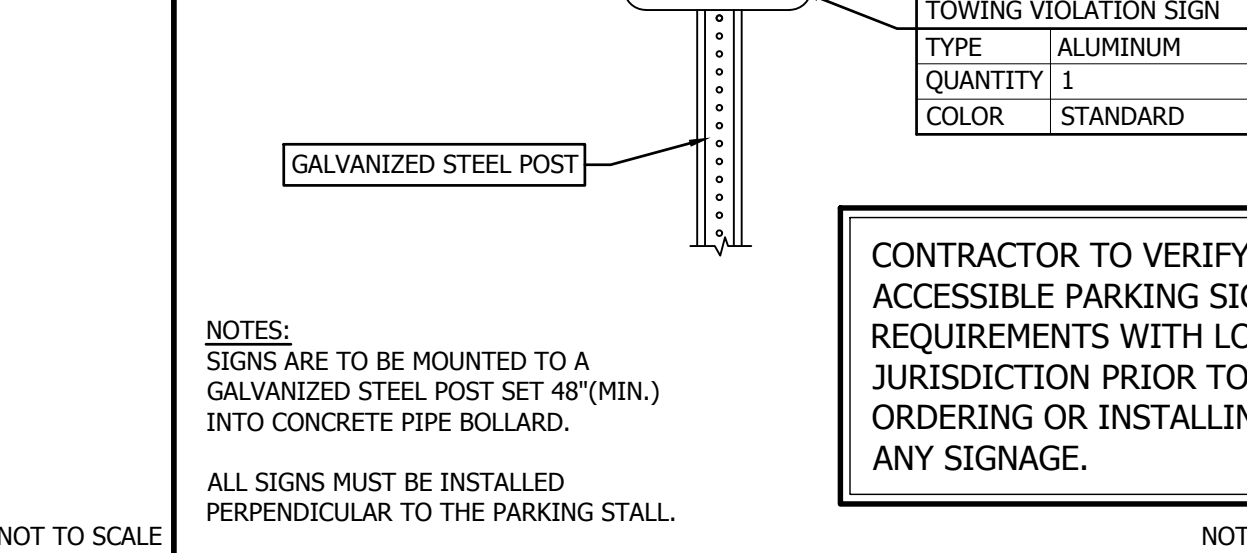

5 EXPANSION AND CONTROL JOINTS

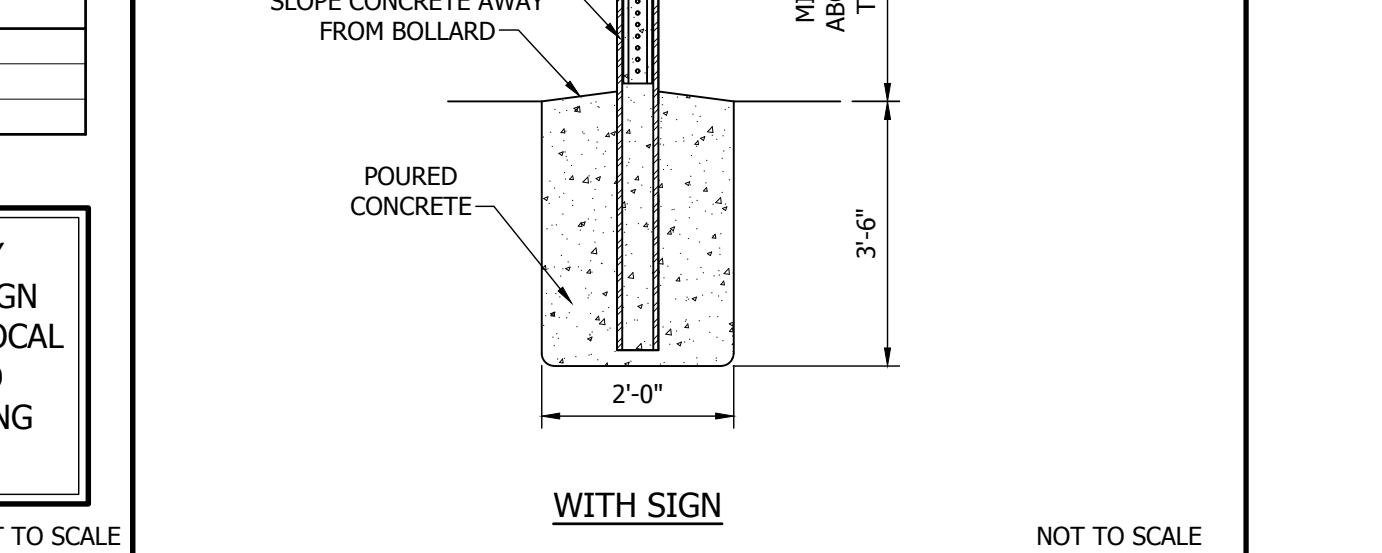

6 PAVEMENT MARKINGS



7 TRASH CORRAL DETAIL

8 6\"/>

9 6\"/>

10 POURED-IN-PLACE CONCRETE RETAINING WALL

11 PEDESTRIAN SAFETY RAILING

12 RAMP DETAIL @ ACCESSIBLE PARKING


13 TAPER END OF CURB

15 PAINTED ACCESSIBLE PARKING SYMBOL


16 ACCESSIBLE PARKING SIGN

17 GUARD POST

SECTION A-A

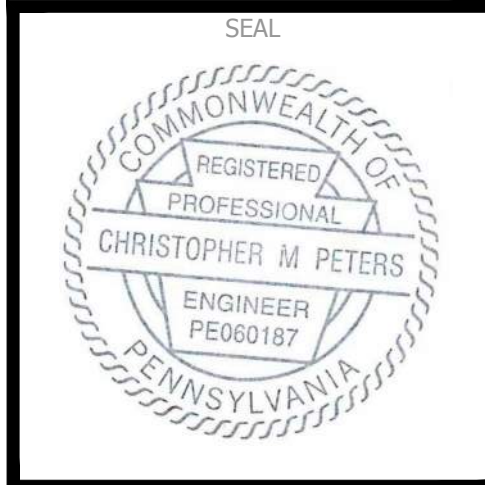

REV.	DATE	DESCRIPTION

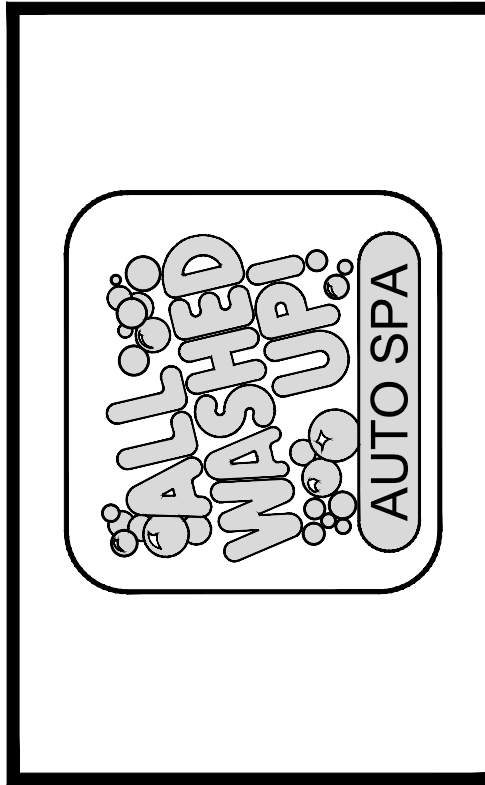

MIDM
SURVEYORS & ENGINEERS, LLC
 Surveyors • Engineers • Site Planners
 375 Northgate Drive
 Warrendale, PA 15086
 Ph: (724) 934-2810 Fax: (724) 934-2811
 midsad@midmllc.com www.midmllc.com

ALL WASHED UP AUTO SPA
 PROJECT: 1380 & 1386 N. ATHONTON STREET
 TOWNSHIP OF FERGUSON, COUNTY OF CENTRE
 COMMONWEALTH OF PENNSYLVANIA

SHEET TITLE: **SITE DETAILS**
 DRAWN BY: CWT
 CHECKED BY: CMP
 ISSUE DATE: 8-29-2022
 SHEET NUMBER: **SP-5**

